CORONA FIRE DEPT BUILDING 2nd FLOOR T.I.



OWNER:


CITY OF CORONA Fire Department 735 Public Safety Way Corona, CA 92878 Telephone (951) 736-2220 Contact: Cindi Schmitz Located at 735 Public Safety Way Corona, CA 92878



ARCHITECTS/ENGINEERS:

PETTITnona Rd. Ste D

1787 Pomona Rd, Ste D Corona, CA 92878 Telephone (951) 736-8161

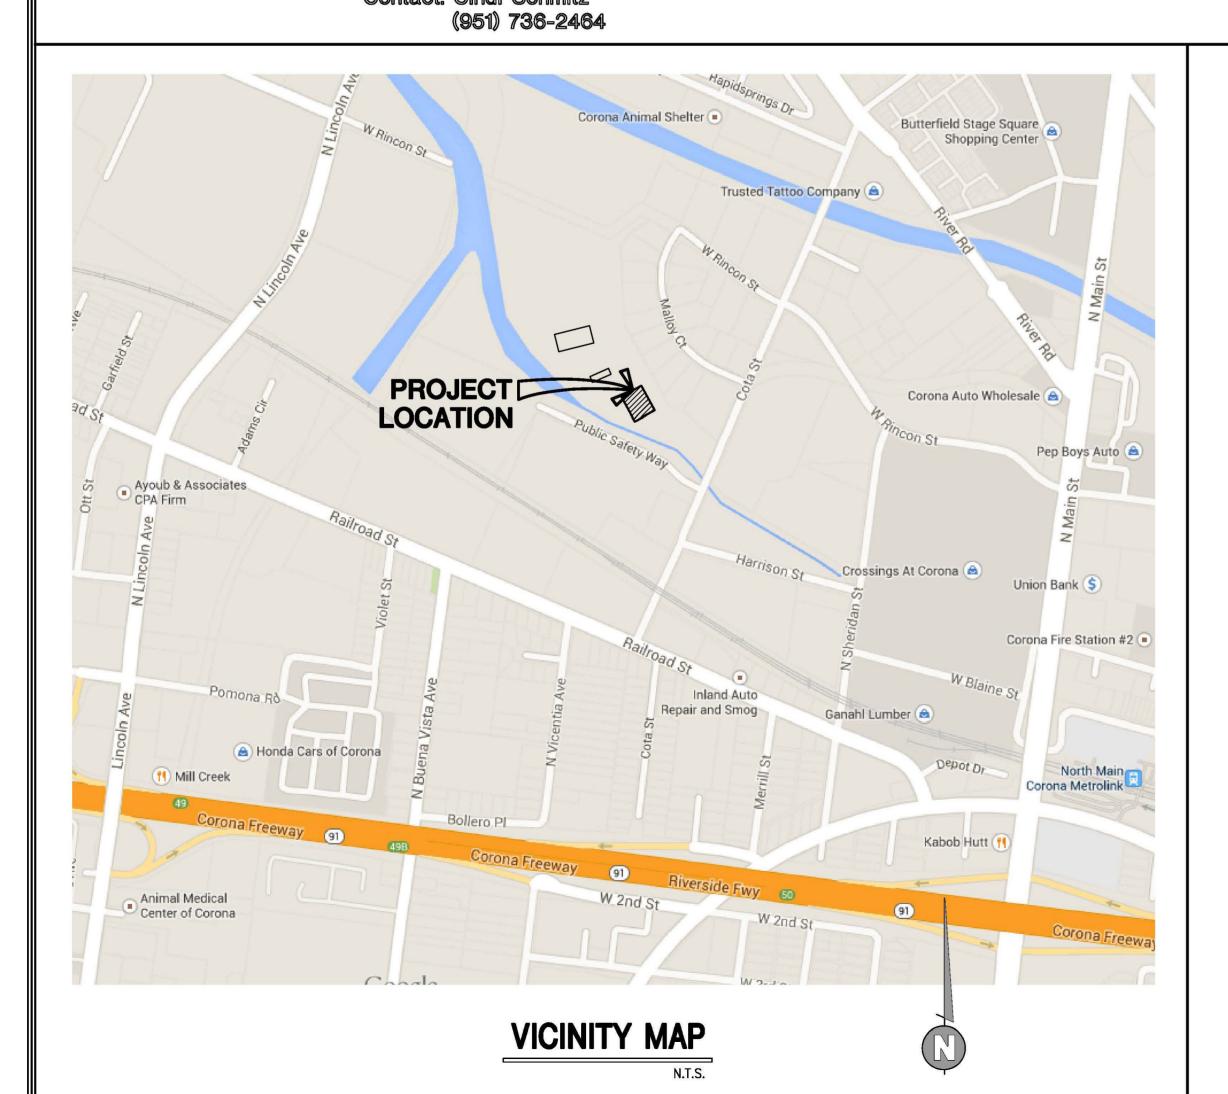

SITE DATA

APN	.119-220-038-2
ZONE	U (UTILITY)
LAND USE	U (UTILITY)
SITE AREA	1,305,058± S.F. (29.96± ACRES)

LEGAL DESCRIPTION

RECORDED BOOK / PAGE: MB 6/20 SB SUBDIVISION NAME: AUBURNDALE COLONY & TOWNSITE LOT/PARCEL: 4, BLOCK: P

NOTE: THIS BUILDING WAS ORIGINALLY APPROVED BY THE CITY ON 7/30/2012 UNDER ACTIVITY #B12-00853.

CODE ANALYSIS - 2019 CBC

ALL CONSTRUCTION SHALL MEET 2019 CBC, CFC, CPC, CMC, CEC & CITY ORDINANCES.

EXIST SMALL CLASSROOM #242A (B OCCUP.). 801 S.F.

NEW USES:	
NEW MEN'S RESTROOM #217 (B OCCUP.)	166 S.F.
NEW OFFICE #1 (B OCCUP.)	. 222 S.F.
NEW OFFICE #2 (B OCCUP.)	160 S.F.
NEW OFFICE #3 (B OCCUP.)	. 134 S.F.
NEW OFFICE #4 (B OCCUP.)	134 S.F.
NEW OFFICE #5 (B OCCUP.)	134 S.F.
NEW RECEPTION AREA (B OCCUP.)	64 S.F.
NEW CUBICLE AREA (B OCCUP.)	. 159 S.F.

EXISTING CONSTRUCTION

TYPE V-B. EXISTING OVERALL BUILDING OCCUPANCY IS B WITH AUTOMATIC FIRE SPRINKLER SYSTEM. EXISTING CONSTRUCTION IS METAL STUD WALLS W/ GYPBD AND EXTERIOR CONCRETE WALLS.

PROPOSED NEW WORK

CONVERTING EXISTING DORM ROOM INTO NEW MEN'S RESTROOM & OFFICE TENANT IMPROVEMENT. NEW CONSTRUCTION WILL BE TYPE V-B, METAL STUD WALLS W/GYPBD & B OCCUPANCY.

THE T.I. WILL MEET TITLE 24 ENERGY / GREEN CODE REQUIREMENTS. CLIENT / CONTRACTOR TO PROVIDE MECHANICAL, PLUMBING & ELECTRICAL AS-BUILTS FOR SUBMITTAL/PLANCHECK REVIEW SEPARATELY FOR APPROVAL.

SHEET INDEX

<u>ARCHITECTURAL</u>


T-1	TITLE, VICINITY MAP & SITE DATA
G-1	GENERAL NOTES, SYMBOLS & ABBREVIATIONS
G-2	EXITING PLANS
D-1	DEMOLITION FLOOR PLANS
D-1.1	DEMOLITION CEILING PLANS
A1.0	OVERALL SITE PLAN - REFERENCE ONLY
A1.1	PARTIAL SITE PLAN - REFERENCE ONLY
A2.0	OVERALL 1ST FLOOR PLAN - REFERENCE ONLY
(A2.1)	OVERALL 2nd FLOOR PLAN - REFERENCE ONLY
	G-1 G-2 D-1 D-1.1 A1.0 A1.1 A2.0


A-2.2 ENLARGED FLOOR PLANS
A-3 REFLECTED CEILING PLANS


A-3 REFLECTE
A-4 DETAILS

NOT A PART OF THIS APPROVAL:

- 1. FIRE SPRINKLERS (AS NEEDED FOR REMODELED AREA).
- CONTRACTOR TO SUBMIT SEPARATE DETAILED FIRE SPRINKLER PLANS FOR ALTERATIONS FOR REVIEW AND APPROVAL.
- 2. FIRE ALARM SYSTEM. CONTRACTOR TO SUBMIT SEPARATE DETAILED FIRE ALARM PLANS FOR ALTERATIONS FOR REVIEW AND APPROVAL. CONTRACTOR TO USE LICENSED FIRE ALARM CONSULTANT.
- 3. SECURITY ALARM SYSTEM.

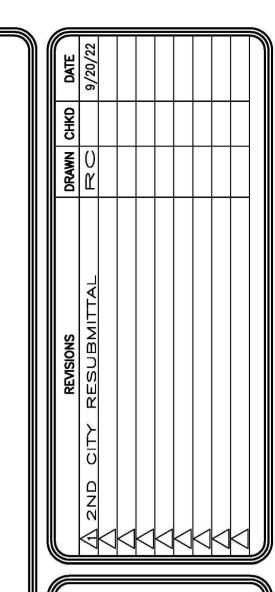

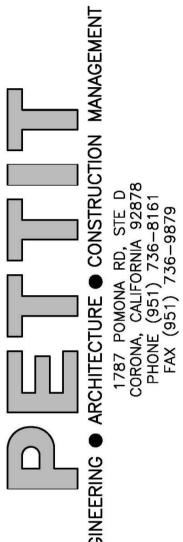

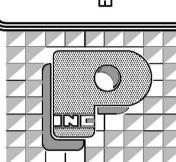



OWNER/CLIENT

CITY OF CORONA 400 S. VICENTIA AVE CORONA, CA 92882

PROJECT TITLE

CORONA FIRE DEPT BLDG 2ND FLOOR T.I. 735 PUBLIC SAFETY WAY CORONA, CA 92878


SHEET TITLE

TITLE SHEET, VICINITY MAP & SITE DATA

DATE	8/13/22
DRAWN	RC
CHECKED	
JOB NO.	22027
SCALE	AS SHOWN
DRAWING N	o. 22-049

T-1

REV.

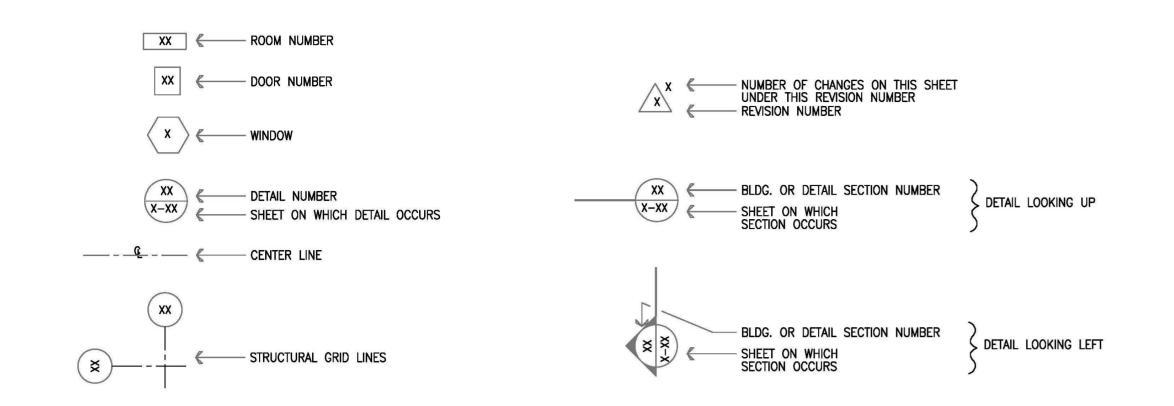

SYMBOLS

						_	
ABV.	ABOVE	DIAG.	DIAGONAL	H.B.	HOSE BIBB	PL	PROPERTY LINE
A.F.F.	ABOVE FINISH FLOOR	DIM.	DIMENSION	H.W.	HOT WATER	P.S.F.	POUNDS PER SQUARE FOOT
A.F.G.	ABOVE FINISH GRADE	DIV.	DIVISION	IN.	INCH	P.T.	PRESSURE TREATED
A.P.	ACCESS PANEL	DO	DITTO	INCL.	INCLUDE	R/RAD.	RADIUS
A.D.	ACCESS DOOR	DR.	DOOR	INFO.	INFORMATION	RWD.	REDWOOD
ACOUS	ACOUSTIC, ACOUSTICAL	DBL.	DOUBLE	I.D.	INSIDE DIAMETER	REF.	REFERENCE
ACPL	ACOUSTICAL PLASTER	DN.	DOWN	INSUL.	INSULATE, INSULATED, INSULATION	REM.	REMOVE
ACT	ACOUSTICAL TILE	DS.	DOWN SPOUT	INT.	INTERIOR	REQ.	REQUIRED
ADD	ADDITION	DWG.	DRAWING	IPW	INSULATED PANEL WALL	R/W	RIGHT OF WAY
ADH.	ADHESIVE	D.F.	DRINKING FOUNTAIN	JAN.	JANITOR		
ALT.	ALTERNATE	EA.	EACH	JT.	JOINT	RFG.	ROOFING
AL.	ALUMINUM	E.W.	EACH WAY	JST.	JOIST	RM.	ROOM
ALLOW.	ALLOWABLE	ELEC.	ELECTRIC, ELECTRICAL	JCT.	JUNCTION	R.O.	ROUGH OPENING
ANC.	ANCHOR, ANCHORAGE	E.P.	ELECTRICAL PANEL	J.B.	JUNCTION BOX	RND.	ROUND
A.B.	ANCHOR BOLT	EL., ELEV.	ELEVATION	KCPL	KEENE'S CEMENT PLASTER	SAN.	SANITARY
&	AND					SCHED.	SCHEDULE
<u>ـ</u>	ANGLE	E.N.	EDGE NAILING	KIT.	KITCHEN	SECT.	SECTION
		ENCL.	ENCLOSE, ENCLOSURE	LAB.	LABORATORY	SHTG.	SHEATHING
ANOD.	ANODIZED	ENGR.	ENGINEER	LAM.	LAMINATE, LAMINATED	SHT.	SHEET
APRX.	APPROXIMATE	E.O.	EDGE OF	LAV.	LAVATORY	S.M. SIM.	SHEET METAL SIMILAR
ARCH.	ARCHITECT, ARCHITECTURAL	EQ.	EQUAL	LTG.	LIGHTING	S.C.	
ASPH	ASPHALT	EQUIP.	EQUIPMENT	L.F.	LINEAR FOOT/FEET	SPEC.	SOLID CORE SPECIFICATION
A.C.	ASPHALT CONCRETE	EST.	ESTIMATE	LOC'N	LOCATION	SQ.	SQUARE
	AT	EXH.	EXHAUST	LVR.	LOUVER	S.F.	SQUARE FOOT, SQUARE FEET
AUTO	AUTOMATIC	(E)	EXISTING	MACH.	MACHINE	S.S.	SELECT STRUCTURAL,
AVE.	AVERAGE	EXIST.	EXISTING	M.B.	MACHINE BOLT	3.3.	STAINLESS STEEL
BSMT.	BASEMENT			MH.	MANHOLE	STD.	STANDARD
BM.	BEAM	E.J.	EXPANSION JOINT	MFR.	MANUFACTURE, MANUFACTURER	STA.	STATION
B.M.	BENCH MARK	EXP	EXPOSED	M.O.	MASONRY OPENING	STL.	STEEL
B.N.	BOUNDARY NAILING	EXT	EXTERIOR	MATL.	MATERIAL	STOR.	STORAGE
B.O.	BOTTOM OF	F.O.C.	FACE OF CONCRETE	MAX.	MAXIMUM	ST.	STREET
B.O.F.	BOTTOM OF FOOTING	F.O.M.	FACE OF MASONRY	MECH'L	MECHANICAL	STR., STR'L	STRUCTURAL
BTWN.	BETWEEN	F.O.S.	FACE OF STUD	MTL	METAL	SUSP.	SUSPENDED
BLK.	BLOCK	FT.	FOOT, FEET			SW.	SWITCH
BLKG.	BLOCKING	FTG.	FOOTING	ML	METAL LATH	SYM.	SYMMETRICAL
BD.	BOARD	FIG.	FIGURE	MEZZ.	MEZZANINE	T&B	TOP AND BOTTOM
B.W.	BOTH WAYS	FIN.	FINISH	MIN.	MINIMUM	TKBD.	TACKBOARD
		F.E.	FIRE EXTINGUISHER	MISC.	MISCELLANEOUS	TEL.	TELEPHONE
BOT.	BOTTOM	F.E.C.	FIRE EXTINGUISHER CABINET	MPH	MILES PER HOUR	T.V.	TELEVISION
BRK.	BRICK	F.D.	FLOOR DRAIN	NAT.	NATURAL		
BLDG.	BUILDING	F.F.L.	FINISH FLOOR LEVEL	(N)	NEW	TEMP.	TEMPERATURE/ TEMPORARY
BUR	BUILT-UP ROOFING	F.H.	FIRE HOSE/	NOM.	NOMINAL	THK.	THICK, THICKNESS
BB	BULLETIN BOARD		FIRE HYDRANT	N.	NORTH	T.O.	TOP OF
С	COMPACT PARKING SPACE	F.H.C.	FIRE HOSE CABINET				
CAB.	CABINET	F.H.R.	FIRE HOSE RACK	N/A	NOT APPLICABLE	T.O.C.	TOP OF CONCRETE
CANT.	CANTILEVER	FIXT.	FIXTURE	N.I.C.	NOT IN CONTRACT	T.O.D.	TOP OF DRAIN
CPT.	CARPET	F.L.	FLOW LINE	N.T.S.	NOT TO SCALE	T.O.P. T.O.S.	TOP OF PARAPET TOP OF STEEL
C.I.	CAST IRON	FPRF.	FIREPROOF	#	NUMBER, POUND	T.O.W.	TOP OF WALL
C.I.P.	CAST IRON PIPE	FTG.	FOOTING	No.	NUMBER	T.U.P.	TILT-UP PANEL
C.B.	CATCH BASIN	GAL.	GALLON	OFF.	OFFICE	TYP.	TYPICAL
CLKG.	CAULKING	GALV.	GALVANIZED	o.c.	ON CENTER	U.N.O.	UNLESS NOTED OTHERWISE
CLG.	CEILING	G.I.	GALVANIZED IRON	OPNG.	OPENING	V.I.F	VERIFY IN FIELD
CEM.	CEMENT	G.	GAS	O.D.	OUTSIDE DIAMETER	V.T.R.	VENT THRU ROOF
CPL	CEMENT PLASTER	GKT.	GASKET, GASKETED			V.T.W.	VENT THROUGH WALL
CL	CENTER LINE	GA.	GAUGE	0/	OVER	VENT.	VENTILATE, VENTILATION
CT	CERAMIC TILE	GL.	GLASS, GLAZING	PR.	PAIR	VERT.	VERTICAL
CL	CHAIN LINK	G.L.B.	GLUED LAMINATED BEAM	PNL.	PANEL	VEST.	VESTIBULE
C.N.	COMMON NAIL	GLU. LAM.	GLUED LAMINATED	PTN.	PARTITION	VCT	VINYL COMPOSITION TILE
C.O.	CLEANOUT	GYP.	GYPSUM	PVMT.	PAVEMENT	V.T.	VINYL TILE
CLR.	CLEAR, CLEARANCE	GP. BD.	GYPSUM BOARD	%	PERCENT	VSF	VINYL SHEET FLOORING
COL.	COLUMN	HW.	HARDWARE	PERP.	PERPENDICULAR		
CONC.	CONCRETE	HWD.	HARDWOOD	PLAM	PLASTIC LAMINATE	WSCT.	WAINSCOT
C.M.U.	CONCRETE MASONRY UNIT	HDR.	HEADER			W.C.	WATER CLOSET
CONST.	CONSTRUCTION	HTG.	HEATING	PL.	PLATE, PROPERTY LINE	W.H.	WATER HEATER
C.J.	CONSTRUCTION JOINT/			PLCS	PLACES	WP.	WATERPROOF, WATERPROOFING
	COLD JOINT	HVAC.	HEATING/VENTILATING/	PLUMB.	PLUMBING	WP.	WEATHERPROOFING
CONT.	CONTINUOUS	UТ	AIR CONDITIONING	±	PLUS OR MINUS	W.W.F.	WELDED WIRE FABRIC
d	PENNY (NAIL WEIGHT)	HT. H.P.	HEIGHT HIGH POINT	PLYWD.	PLYWOOD	WDW.	WINDOW
\triangle	DELTA					w/	WITH
	DIAMETER	H.C.	HOLLOW CORE	PT.	POINT	w/o	WITHOUT
ø, DIA.		H.M.	HOLLOW METAL	P.O.C.	POINT OF CONNECTION	WD.	WOOD
ø, DIA. DEM.	DEMOLITION, DEMOLISH					110.	WOOD
	DEMOLITION, DEMOLISH DEPARTMENT	HORIZ.	HORIZONTAL	P.V.C.	POLYVINYL CHLORIDE	W.I.	WROUGHT IRON
DEM.			HORIZONTAL HOUR	P.V.C. P.C.C.	POLYVINYL CHLORIDE PORTLAND CEMENT CONCRETE		

GENERAL NOTES

- All work shall comply with the applicable requirements of the City of Corona, State of California, and other applicable governing codes and building ordinances, and the 2019 edition of the California
- PERMITS: The general building permit and plan check fee shall be secured and paid for by the Owner. All other permits shall be taken out and paid for by the Contractor directly responsible.
- SUBSTITUTION: No substitutions shall be made without the Owner's and Architect's written approval.
- INTENTION: The intention of the documents is to include all labor, materials, equipment and transportation necessary for complete and proper execution of the work.
- CHANGES: The Owner may order extra work or make changes by altering, adding to, or deducting from the work; the contract sum being adjusted accordingly.
- CUTTING AND PATCHING: All trades shall do their own cutting, fitting, patching, etc., to make the several parts come together properly and fit to receive or be received by work of other trades.
- 7. SCOPE: All trades shall furnish all labor, equipment. materials, and perform all work necessary, indicated, reasonable, inferred or required by any code with jurisdiction to complete their scope of work for a complete and properly finished iob.
- CLEAN-UP: All trades shall, at all times, keep the premises free from accumulation of waste materials or rubbish caused by their work.
- TEMPORARY TOILETS: The General Contractor shall provide temporary toilet facilities for all trades until completion of the work.
- 10. LINES AND LEVELS: The Contractor shall be responsible for the accuracy of the building lines and levels. The Contractor shall compare carefully the lines and levels shown on the drawings with existing levels for the location and construction of the work and shall call the Architect's attention to any discrepancies before proceeding with the work.
- 11. Contractor shall verify conditions at the site and report any discrepancies to the Architect <u>before</u> proceeding with the work.
- 12. Dimensions shown on floor plans, sections, and details are to center of column, grid lines, and face of concrete walls. unless otherwise noted or indicated.
- 13. The design, adequacy and safety of erection bracing, shoring, temporary supports, etc., is the sole responsibility of the Contractor, and has not been considered by Pettit Inc. The Contractor is responsible for the stability of the structure prior to the application of all shear walls, roof and floor diaphragms and finish materials. He shall provide the necessary bracing to provide stability prior to the application of the aforementioned materials. Obserclude inspection of the above items.
- 14. It shall be the responsibility of the contractor to locate all existing utilities whether shown hereon or not and to protect them from damage. The Contractor shall bear all expense of repair or replacement in conjunction with the prosecution of this
- 15. The Architect's review of shop drawings shall not relieve the General Contractor or Sub-Contractor from responsibility for deviations from the drawings or specifications unless he has, in writing, called the Architect's attention to such deviations at the time of submissions, nor shall it relieve him from the responsibility for errors of any sort in the shop drawings.
- 16. Framing Contractor shall check and verify size and location of plumbing runs with Mechanical Contractor before framing walls, floors, etc.
- 17. Provide stiffeners, bracing, back-up plates, etc., as required at stud walls for support of toilet room fixtures or other equipment.
- 18. Door locations not established by dimension shall be centered in wall or 5" from finish wall to finish jamb where feasible.
- 19. Comply with CBC for pedestrian protection during
- 20. Sizes of mechanical equipment pad bases are approximate only. Contractor shall verify dimensions of all pads and bases with equipment manufactur-
- 21. Contractor to obtain CAL-OSHA permit for construction.
- 22. Not used.
- 23. Suspension system shall provide for ceiling, lighting fixtures and air conditioning diffusers. Provide independent framing and attachments to structure, adequate to support the ceiling system where ductwork interferes with normal suspension or attachment of hangers or framing to ductwork is prohibit—
- 24. Where gypsum board layers differ, studs are to be offset to permit a continuous smooth finish line in all corridors or where such conditions occur.
- 25. Maintain egress and access to building at all times. Do not close or obstruct entrance access.

GENERAL NOTES (cont.)

- 26. All exits shall have signs and all blind corridor turns shall have directional exit signs.
- 27. All exit doors shall be openable from the inside without the use of a key or any special knowledge
- 28. All exterior doors shall limit air leakage around their perimeter when in a closed position.
- 29. Open exterior joints around window and door frames, joints between walls and foundations, joints between walls and roof, joints between wall panels, and joints at penetrations of utilities through the envelope shall be sealed, caulked, or weatherstripped to limit air leakage.
- 30. Panic hardware shall be provided on all exit doors serving rooms, corridors, or stairways handling an occupant load capacity of 50 or more persons. (Title 19, State Building Code & Chapter 10, CBC)
- 31. Glass doors, adjacent panels, and all glazed openings within 18" of the adjacent floor shall be of glass approved for impact hazard (tempered alass).
- 32. All glass lights over 6 square feet in area, within 18" of floor or grade, shall be fully tempered, or
- 33. Contractor to provide all required wiring and rewiring required to complete the proposed job.
- 34. All sheet metal flashings to be minimum 26 ga. galvanized steel or bonderized. (U.N.O.)
- 35. Door subcontractor shall field verify door opening sizes prior to ordering. Maximum effort to operate doors shall not exceed 8 1/2 pounds for exterior doors and 5 pounds for interior doors. Such effort shall be applied at right angles to hinged doors. Latching and locking doors shall be with a single effort by hardware designed to provide passage without the ability to grasp. Doors shall be operable from the inside without the use of a key or any special knowledge.
- 36. Location of all mechanical roof openings shall be determined or verified by mechanical contractor.
- 37. If gas service is provided, also provide outside gas shut-off valve conspicuously marked.
- 38. Contractor shall verify with the proper utility company the location of all existing below ground utilities and their service connection.
- 39. Finish grading shall be uniformly sloped away from the building for drainage.
- 40. New concrete walks shall be 4 inches thick unless otherwise noted.
- 41. Building structure shall comply with Title 24 (State Building Code) "Disabled Accessibility"
- 42. A "Certificate of Compliance" signed by the owner, General Contractor, Architect, or Engineer shall be given to the Building Department stating that the work has been performed and materials installed according to the plans and specifications affecting
- 43. Contractor to submit samples prior to installation to owner or Architect / Project Engineer.
- 44. The highest and lowest operable part of all controls, receptacles, and other operable equipment shall be placed within 48" of the floor but no lower than 15" if forward approached and within 54" but no lower than 9" if side approached. Electrical and communication system receptacles on walls shall be mounted no less than 15" above the floor.
- 45. Controls and operating mechanisms shall be operable with one hand and shall not require tight grasping, punching, or twisting of the wrist. The force required to activate controls shall be no greater than 5 pounds of force.

FIRE DEPARTMENT NOTES

- 1. Provide a Class "A" Roofing Material.
- 2. Provide a minimum twenty—five (25) foot inside and fifty (50) foot outside radius for access drives.
- Not used.
- 4. Not used.
- 5. An approved fire sprinkler system shall be submitted to the Building Department and shall be approved by the Fire Department prior to system installation.
- 6. All projects shall comply with the City of Corona Fire Department Site construction Standard. A copy of which is available at the Fire Department Counter. Projects shall have approved all weather access from two (2) directions and fire hydrants providing the required fire flow tested and accepted prior to combustible construction.
- 7. Provide a (1) inch = 200 foot scale of site plan prior to issuance of Certificate of occupancy to the Fire Department.
- 8. Fire extinguishers shall be provided prior to occupancy. Fire extinguishers shall bear a California State Marshal's service tag; it shall be appropriately rated for the hazard; shall be mounted so that the top of the extinguisher is no higher than five (5) feet above floor level; and shall be located such that travel distance to an extinguisher does not exceed seventy-five (75) feet.
- 9. Not used.
- 10. Occupant shall obtain Fire Department permits as required by CFC prior to occupancy of building.
- 11. Not used.
- 12. The Developer shall meet with the Fire Department prior to construction to determine the location of: Fire Department connections for sprinkler systems, post indicator valves, etc.
- 13. Required Fire Department access and exit doors shall not be obstructed by parking, landscaping, trash enclosures, etc., nor shall the access and exit obstruct drives.
- 14. Schedule a Certificate of Occupancy inspection/building final inspection prior to occupancy of this structure/improvement area.
- 15. Not used.
- 16. Drive gisle widths shall be 28'-0" minimum.
- 17. Separate permit required for modifications to existing fire sprinkler system. Plans for modifications to any fire extinguishing system and/or fire alarm system shall be reviewed and approved by the Fire Department prior to commencement of work on said systems.
- 18. Not used.
- 19. If Fire Department inspection is required. Inspections to be scheduled 24 hours in advance. Inspection fees to be paid at Fire Department counter, City Hall. This fee is independent of any fees collected by the Building Department.
- 20. Locations and classifications of fire extinguishers shall be in accordance with 2019 CFC, Sect 906 and placement shall be subject to approval of the fire inspector.
- 21. Not used.
- 22. Interior finish, furnishings and decorations shall meet the CFC 803

PLANNING DEPARTMENT **PUBLIC WORKS DEPARTMENT**

- All development and use of this site shall conform to the requirements of the following zone: U (Utility).
- 2. The project shall comply with all applicable requirements of the Corona Municipal Code (CMC) and ordinances and the relevant Specific Plan, if any, including the payment of all required fees.
- 3. The applicant agrees to defend, indemnify, and hold harmless the City of Corona or its agents, officers, and employees from any claim, action or proceeding against the City of Corona or its agents, officers, or employees to attack, set aside, void or annual any approval of the City of Corona, whether by its City Council, Planning Commission or other authorized board or officer. The City of Corona shall promptly notify applicant of any such claim, action or proceeding, and the City

BLDG. DEPARTMENT NOTES

- Access, sanitary facilities, and parking shall comply with Title 24 Disabled Access requirements.
- 2. Contractor shall provide separate permits for all fences, walls, and paving.


of Corona shall cooperate fully in the defense.


- 3. All contractors must show proof of State and City Licenses, and Workmen's Compensation Insurance to the City prior to the issuance of permits.
- Business shall not open for operation prior to posting of Certificate of Occupancy issued by the City of Corona Building Department.
- Construction activity shall not occur between the hours of 8:00 p.m. to 7:00 a.m.. Monday thru Saturday and 6:00 p.m. to 10:00 a.m. on Sundays and Federal

- 1. Any public improvements damaged during construction shall be repaired, or replaced, by the Contractor to the satisfaction of the City Engineer.
- 2. A Public Works Construction Permit is required for any work done within the public right-of-way. (Including underground telephone and/or electrical
- 3. At the time of building permit, Contractor shall comply with all applicable Building Plan Submittal Requirements (a copy is available at the public
- 4. Contractor shall construct, repair and/or replace/missing public improvements.
- 5. All proposed utilities to be installed underground, as determined by the City
- Grading / BMP notes:

knowledge and belief.

- Excavations below existing finished grade are for footings for the construction of a building only and will be authorized by a Building Permit.
- Any cut or fill shall not exceed 100 cubic yards of material nor exceed 100 foot in depth or height. • If more than 100 cubic yards of cut and fill is being moved on the project site, a grading permit shall be required from the Public Works Dept.
- . We, the Architect, Engineer, Contractor and Property Owner(s) of a project herein the attached set of drawings, understand that said information will be a basis for subsequent City action on the project proposed and described hereon. We, the the Architect, Engineer, Contractor and Property Owner(s) also understand that approval of this request does not relieve us from the responsibilities to provide necessary protection to "life, limb and property" as intended by Corona Municipal Code Section No. 15.36, which retention of a soil's engineer's service is considered an essential part of this protection. We certify that all information submitted with and within this set of drawings attached hereto is true and accurate to the best of our
- Erosion and sediment control Best management Practices (BMPs) shall be implemented and maintained to minimize and/or prevent the transport of soil from the construction site.
- Appropriate BMPs for construction related materials, wastes, spills or residues shall be implemented to eliminate or reduce transport from the site to streets, drainage facilities or adjoining properties by wind or runoff.

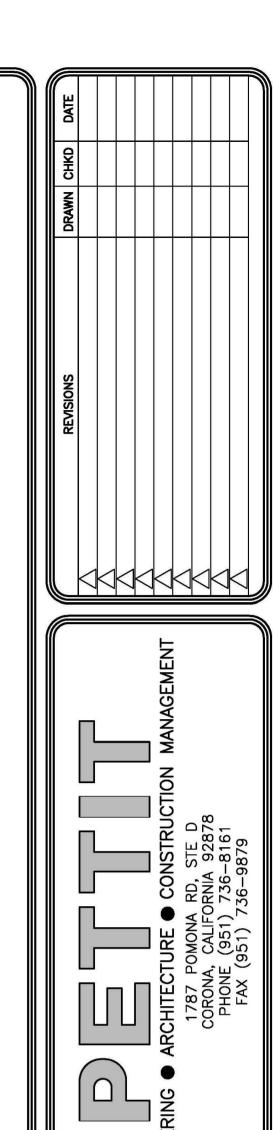

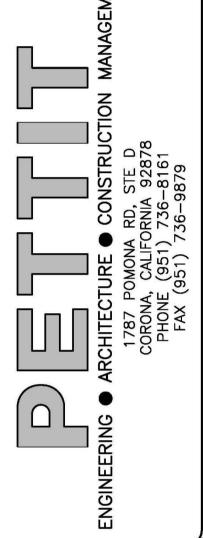



OWNER/CLIENT CITY OF CORONA

PROJECT TITLE CORONA FIRE DEPT BLDG 2ND FLOOR T.I. 735 PUBLIC SAFETY WAY

CORONA, CA 92878

GENERAL NOTES, SYMBOLS AND ABBREVIATIONS

400 S. VICENTIA AVE


CORONA, CA 92882

SHEET TITLE

DATE 8/13/22 DRAWN CHECKED JOB NO. **SCALE** AS SHOWN DRAWING No. 22-047

G-1 REV. 00

ARCHITECTURAL ABBREVIATIONS

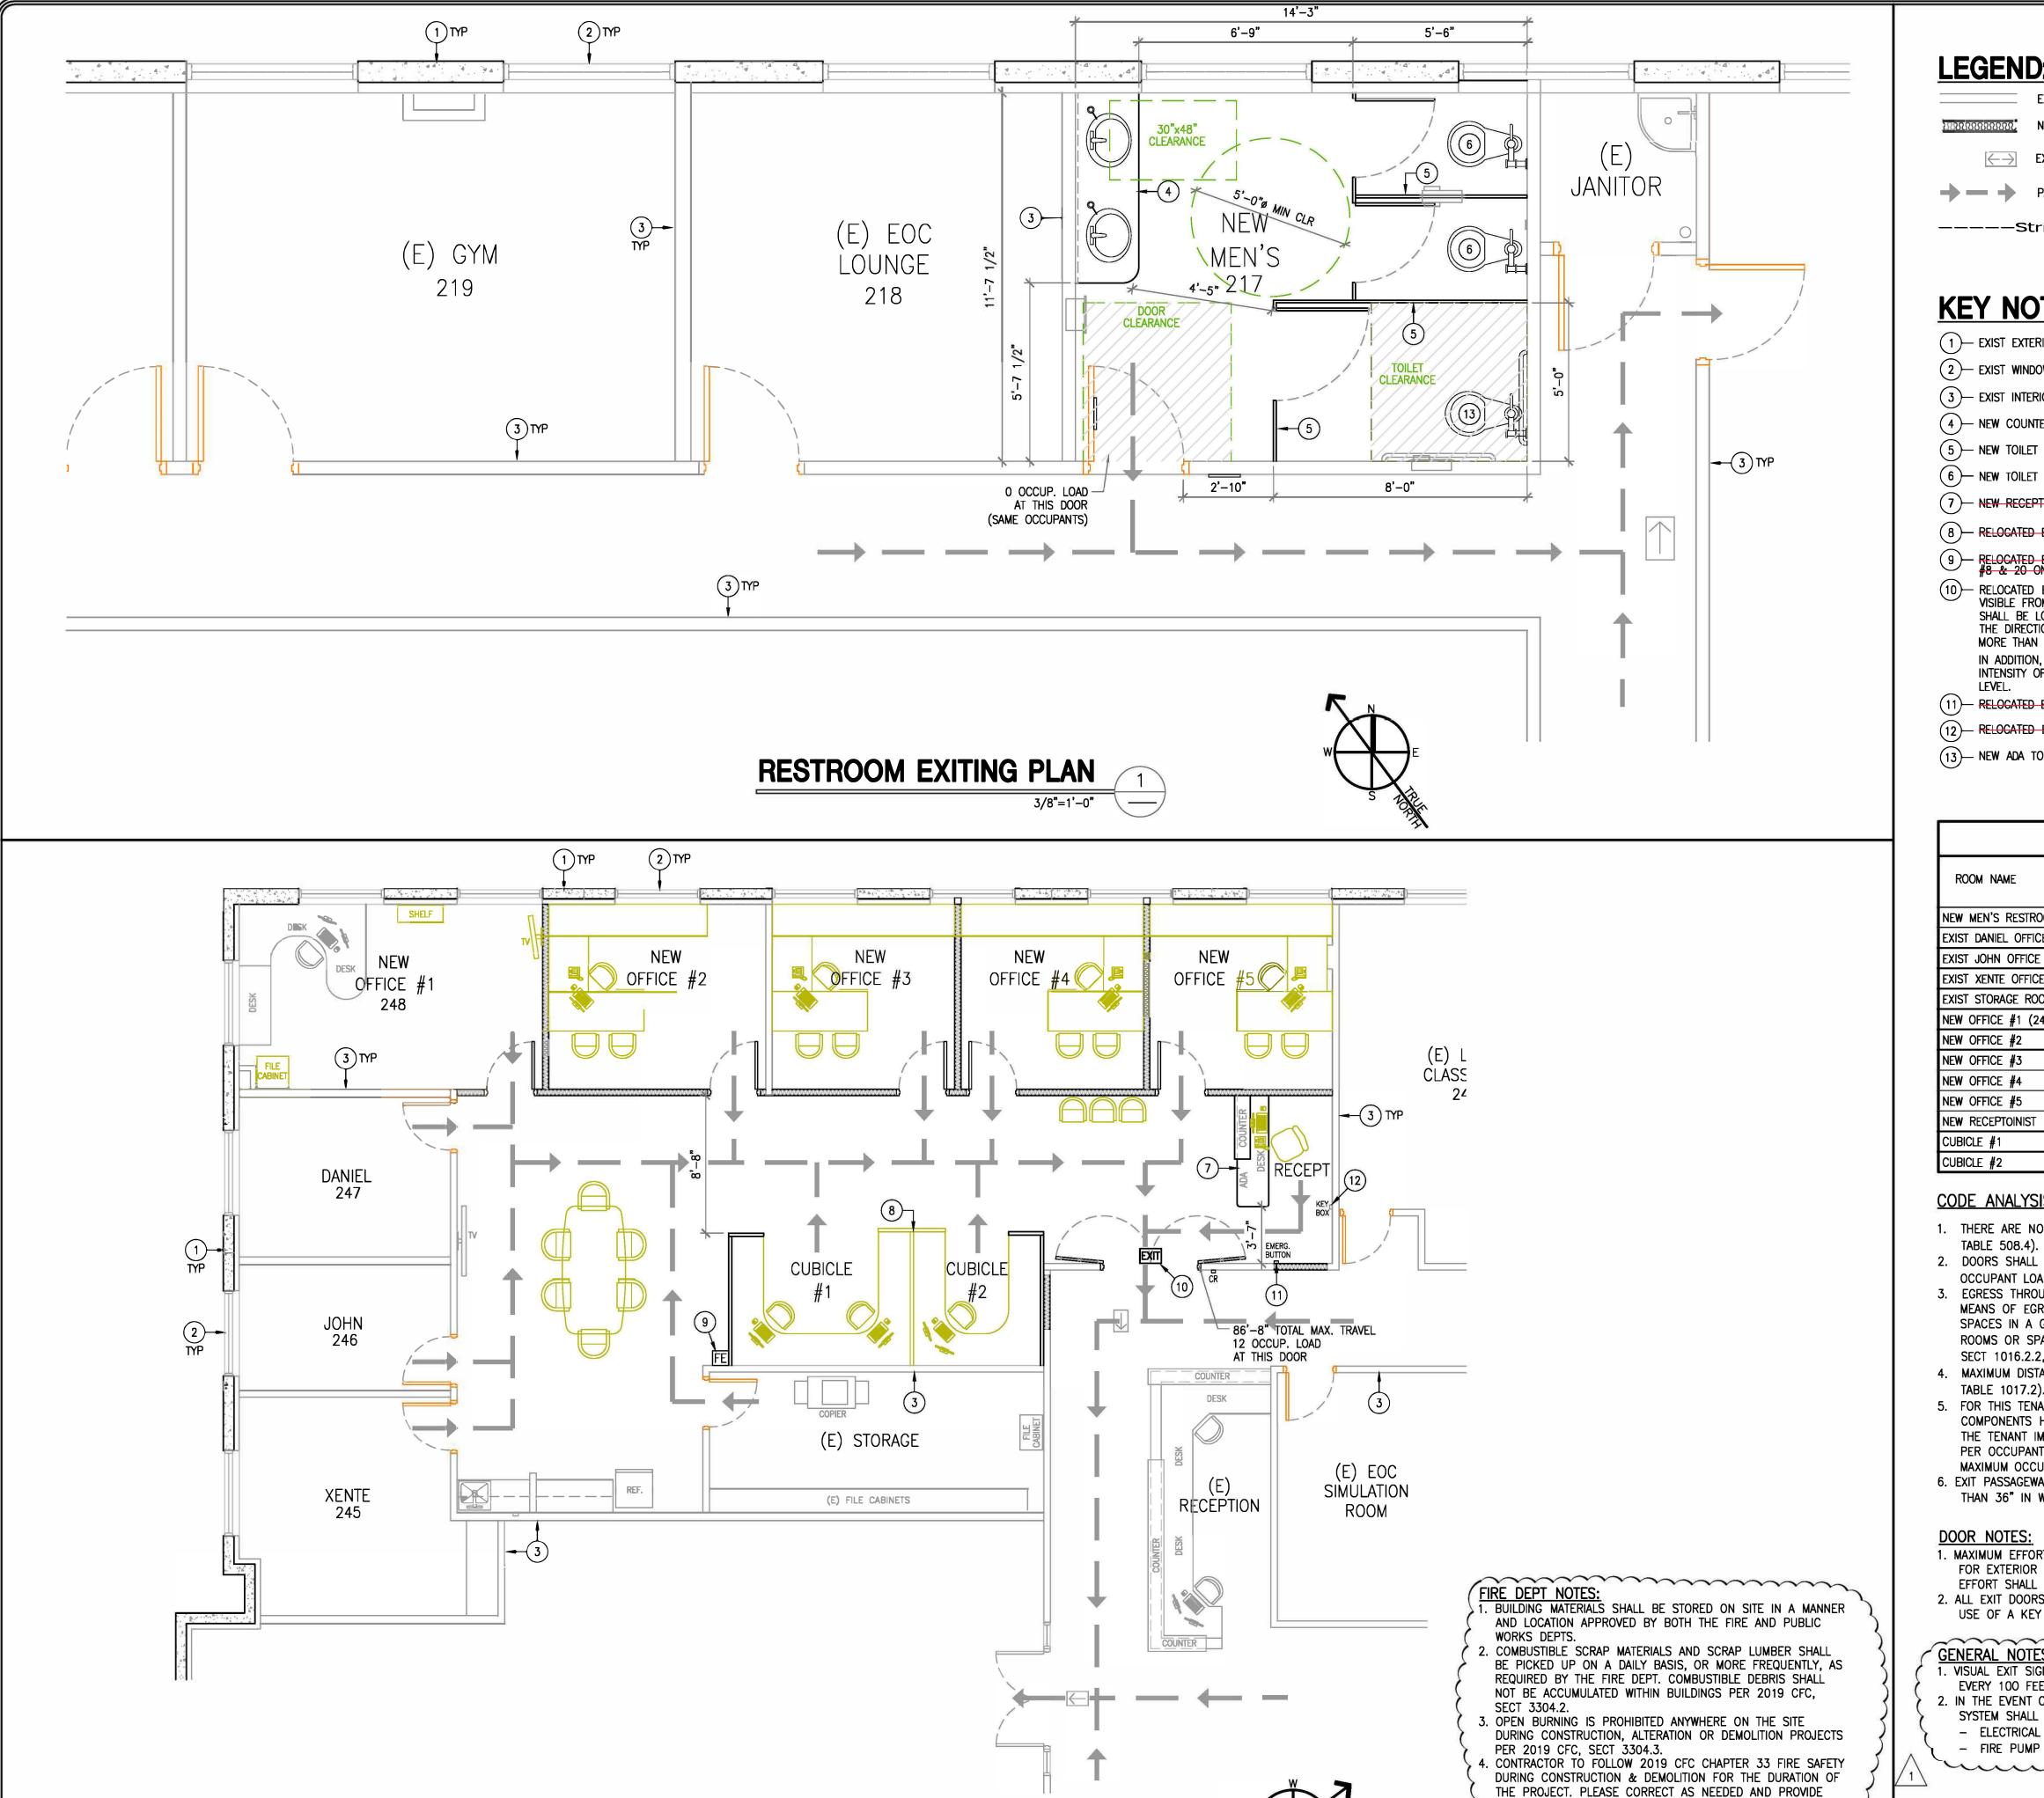

OFFICE EXITING PLAN

LEGEND:

EXIST TO REMAIN

NEW STUD WALL

EXIST DIRECTIONAL EXIT SIGN

PATH OF EXIT TRAVEL

----Strike-thrOugh t0 be handled by City Staff

KEY NOTES

- (1)— EXIST EXTERIOR CONC TILT-UP WALL
- (2)— EXIST WINDOW
- (3)— EXIST INTERIOR PARTITION WALL
- (4)— NEW COUNTER-TOP & SINKS
- 5 NEW TOILET PARTITION
- 7)— NEW RECEPTION COUNTER
- 8 RELOCATED EXIST CUBICLE
- 9 RELOCATED EXIST FIRE EXTINGUISHER. SEE NOTES #8 & 20 ON SHT C-1
- 10— RELOCATED EXIST EXIT SIGN. EXIT SIGN SHALL BE READILY VISIBLE FROM ANY DIRECTION OF APPROACH. EXIT SIGN SHALL BE LOCATED AS NECESSARY TO CLEARLY INDICATE THE DIRECTION OF EGRESS TRAVEL. NO POINT SHALL BE MORE THAN 100 FEET FROM THE NEAREST VISIBLE SIGN. IN ADDITION, EXISTING ILLUMINATED EXIT SIGN TO HAVE AN INTENSITY OF NOT LESS THAN 1 FOOT-CANDLE AT FLOOR
- (11)— RELOCATED EXIST EMERCENCY BUTTON
- (12)— RELOCATED EXIST KEY BOX
- (13)— NEW ADA TOILET

	CO	DE A	NALYSIS	¥5.	
ROOM NAME	OCCUP.	FLR. AREA	OCCUP. LOAD FACTOR PER 2019 CBC, TABLE 1004.5	OCCUP. LOAD	EXITS REQ. PER 2019 CBC TABLE 1006.2.1
NEW MEN'S RESTROOM #217	В	166 SF	N/A	N/A	N/A
EXIST DANIEL OFFICE #247	В	134 SF	150	1	1
EXIST JOHN OFFICE #246	В	105 SF	150	1	1
EXIST XENTE OFFICE #245	В	197 SF	150	1	1
EXIST STORAGE ROOM	В	187 SF	300	1	1
NEW OFFICE #1 (248)	В	222 SF	150	1	1
NEW OFFICE #2	В	160 SF	150	1	1
NEW OFFICE #3	В	134 SF	150	1	1
NEW OFFICE #4	В	134 SF	150	1	1
NEW OFFICE #5	В	134 SF	150	1	1
NEW RECEPTOINIST	В	64 SF	150	1	1
CUBICLE #1	В	93 SF	150	1	1
CUBICLE #2	В	66 SF	150	1	1

CODE ANALYSIS NOTES:


- 1. THERE ARE NO FIRE SEPARATION WALLS REQUIRED BETWEEN B OCCUPANCIES (2019 CBC,
- 2. DOORS SHALL SWING IN THE DIRECTION OF EGRESS TRAVEL WHERE SERVING AN
- OCCUPANT LOAD OF 50 OR MORE PERSONS (2019 CBC, SECT 1010.1.2.1).
- 3. EGRESS THROUGH INTERVENING SPACES: MEANS OF EGRESS ARE NOT PROHIBITED THROUGH ADJOINING OR INTERVENING ROOMS OR SPACES IN A GROUP H, S OR F OCCUPANCY WHEN THE ADJOINING OR INTERVENING ROOMS OR SPACES ARE THE SAME OR A LESSER HAZARD OCCUPANCY GROUP (2019 CBC, SECT 1016.2.2, EXCEPTION).
- 4. MAXIMUM DISTANCE OF TRAVEL ALLOWED FOR B OCCUPANCY IS 300 FEET (2019 CBC, TABLE 1017.2).
- 5. FOR THIS TENANT IMPROVEMENT THE CAPACITY, IN INCHES, OF MEANS OF EGRESS
- COMPONENTS HAS BEEN CALCULATED BY MULTIPLYING THE OCCUPANT LOAD SERVED BY THE TENANT IMPROVEMENT AREA BY A MEANS OF EGRESS CAPACITY FACTOR OF 0.15 INCH PER OCCUPANT PER 2019 CBC, SECT 1005.3.2, EXCEPT 1. MAXIMUM OCCUPANCY LOAD ALLOWED ON ONE 36 INCH DOOR IS 240.
- 6. EXIT PASSAGEWAYS SERVING AN OCCUPANT LOAD OF LESS THAN 50 SHALL NOT BE LESS THAN 36" IN WIDTH AND UNOBSTRUCTED (2019 CBC, SECT 1024.2).


DOOR NOTES:

CONSISTENCY THROUGHOUT (2019 CFC, SECT 105.4.1).

- 1. MAXIMUM EFFORT TO OPERATE DOORS SHALL NOT EXCEED 8 1/2 POUNDS FOR EXTERIOR DOORS AND 5 POUNDS FOR INTERIOR DOORS. SUCH EFFORT SHALL BE APPLIED AT RIGHT ANGLES TO HINGED DOORS.
- 2. ALL EXIT DOORS SHALL BE OPENABLE FROM THE INSIDE WITHOUT THE USE OF A KEY OR ANY SPECIAL KNOWLEDGE OR EFFORT.

- GENERAL NOTES: 1. VISUAL EXIT SIGNS ARE REQUIRED WHENEVER TWO EXITS ARE REQUIRED,
- EVERY 100 FEET.
- 2. IN THE EVENT OF POWER SUPPLY FAILURE, AN EMERGENCY ELECTRICAL SYSTEM SHALL AUTOMATICALLY ILLUMINATE THE FOLLOWING AREAS:
- ELECTRICAL EQUIPMENT ROOMS (IF ANY).
- (IF ANT).

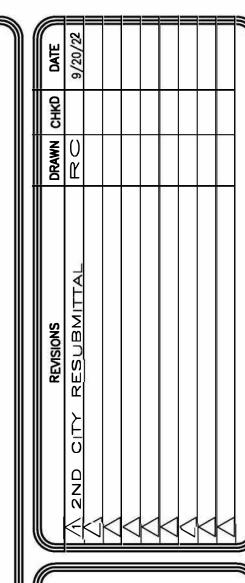

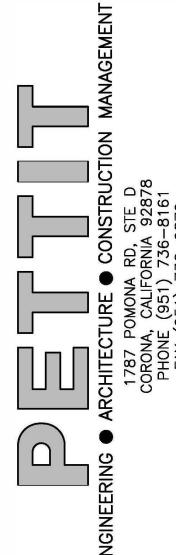



OWNER/CLIENT

CITY OF CORONA 400 S. VICENTIA AVE CORONA, CA 92882

PROJECT TITLE


CORONA FIRE DEPT BLDG -2ND FLOOR T.I. 735 PUBLIC SAFETY WAY CORONA, CA 92878

SHEET TITLE

EXITING PLAN & CODE ANALYSIS

1	DATE	8 <u>/</u> 13 <u>/</u> 22
Ш	DRAWN	RC
Ш	CHECKED	
Ш	JOB NO.	22027
Ш	SCALE	AS SHOWN
	DRAWING	No. 22-048
Ш		

G-2

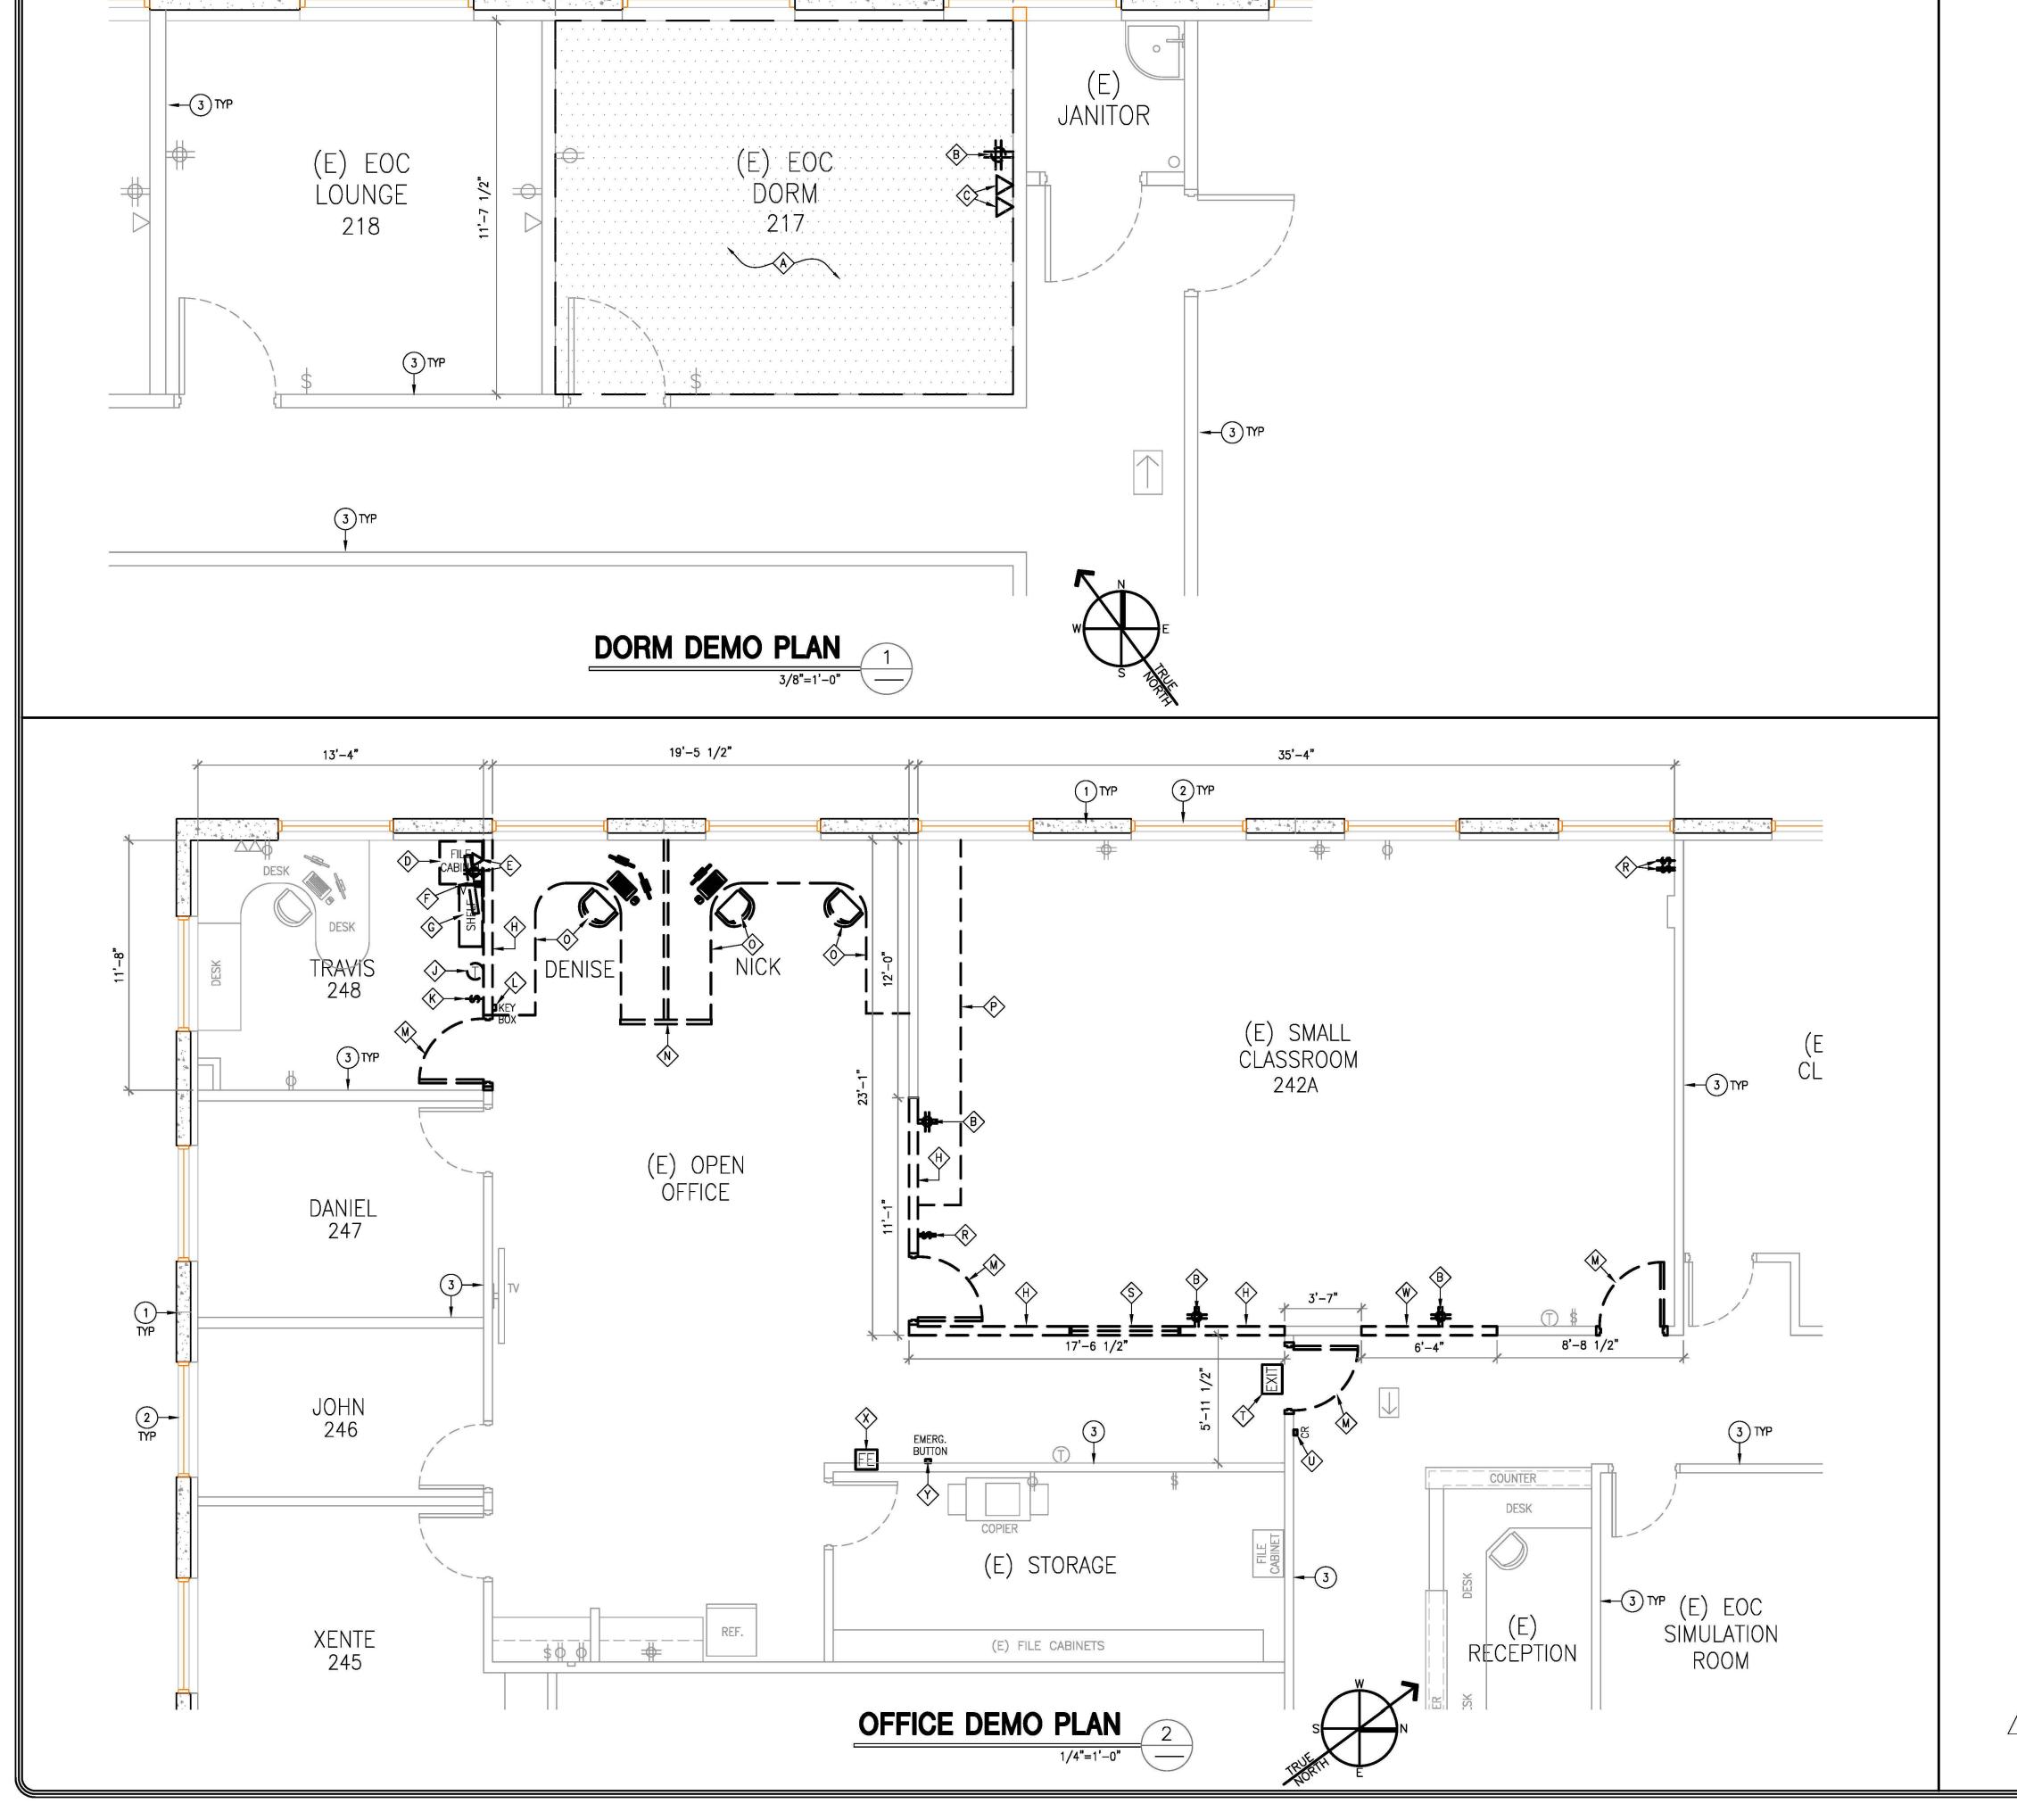

14'-3"

LEGEND:

EXIST TO REMAIN **===** EXISTING TO BE REMOVED

EXIST DIRECTIONAL EXIT SIGN

EXIST ELECT SWITCH

EXIST ELECT OUTLET

EXIST DATA JACK

EXIST THERMOSTAT

-----Strike-through to be handled by City Staff

KEY NOTES

- 1)— EXIST EXTERIOR CONC TILT-UP WALL
- 2 EXIST WINDOW
- 3)— EXIST INTERIOR PARTITION WALL


DEMOLITION NOTES


- A EXIST CARPET, PADDING, TACK STRIP & COVE BASE TO BE REMOVED
- (B)— EXIST OUTLET TO BE REMOVED & CAPPED
- C EXIST DATA/PHONE JACK TO BE REMOVED &
- D EXIST FILE CABINET TO BE RELOCATED. SEE FLOOR PLAN FOR NEW LOCATION
- EXIST HIGH LEVEL OUTLET & DATA JACK TO BE RELOCATED. CONTRACTOR TO ADJUST WIRING AS NECESSARY PER CODE
- F EXIST WALL MOUNTED TV TO BE RELOCATED. CONTRACTOR TO ADJUST WIRING AS NECESSARY
- G EXIST BOOK SHELF TO BE RELOCATED. SEE FLOOR PLAN FOR NEW LOCATION
- (H)— PORTION OF EXIST STUD WALL TO BE REMOVED
- J EXIST THER≤OSTAT TO BE RELOCATED. CONTRACTOR TO ADJUST WIRING AS NECESSARY PER CODE
- (K)— EXIST ELECTRICAL SWITCH TO BE RELOCATED. CONTRACTOR TO ADJUST WIRING AS NECESSARY PER CODE
- EXIST KEY BOX TO BE RELOCATED. SEE FLOOR PLAN FOR NEW LOCATION
- M EXIST DOOR, HARDWARE & FRAME TO BE RELOCATED. SEE FLOOR PLAN FOR NEW LOCATION
- N EXIST CUBICLE TO BE RELOCATED. SEE FLOOR PLAN FOR NEW LOCATION
- (0)— EXIST FURNITURE TO BE RELOCATED. SEE FLOOR
- PLAN FOR NEW LOCATION P EXIST BASE CABINETRY TO BE REMOVED
- (R)— EXIST ELECT SWITCH TO BE REMOVED & CAPPED
- (S)— EXIST WINDOW & FRAME TO BE REMOVED
- (T)— EXIST EXIT SIGN TO BE RELOCATED. CONTRACTOR TO ADJUST WIRING AS NECESSARY PER CODE
- (U)— EXIST CARD READER TO BE RELOCATED. CONTRACTOR TO ADJUST WIRING AS NECESSARY
- PORTION OF EXIST STUD WALL TO BE REMOVED TO ACCOMMODATE FOR NEW DOUBLE DOOR
- X EXIST FIRE EXTINCUISHER TO BE RELOCATED. SEE FLOOR PLAN FOR NEW LOCATION
- Y EXIST EMERGENCY BUTTON TO BE RELOCATED. CONTRACTOR TO ADJUST WIRING AS NECESSARY PER CODE

SECT 105.4.1).

- <u>DEMOLITION NOTES:</u>

 1. THE PLANS ON THIS PAGE ARE BASED ON A LIMITED SURVEY OF THE
- **EXISTING** CONDITIONS. THE CONTRACTOR SHALL VERIFY ALL CONDITIONS SHOWN AND
- BECOME FAMILIAR WITH SITE CONDITIONS PRIOR TO BEGINNING WORK. 2. THE CONTRACTOR SHALL DEMOLISH AND REMOVE FROM THE CONSTRUCTION AREA ELEMENTS WITHIN THE AREA OF THE NEW WORK WHICH ARE NOT A
- OF THE NEW WORK, AND ARE NOT TO BE SAVED.
- 3. THE CONTRACTOR SHALL REMOVE, CAP, OR CONCEAL BEHIND FINISHED SURFACES ANY PROJECTING OR SURFACE MOUNTED ITEMS WHICH ARE NOT A PART OF THE NEW CONDITION.
- 4. THE CONTRACTOR SHALL PATCH AND LEVEL THE EXISTING FLOOR SURFACE WHERE DEMOLITION CAUSES UNEVENNESS OR VOIDS.
- 5. THE CONTRACTOR SHALL PROVIDE SHORING, BRACING, OR OTHER SUPPORT AS REQUIRED DURING DEMOLITION.
- 6. PROTECT EXISTING STRUCTURES AND UTILITIES WHICH ARE NOT TO BE
- DEMOLISHED. 7. CONTRACTOR TO PROVIDE, ERECT AND MAINTAIN TEMPORARY BARRIERS
- AS REQUIRED FOR SAFETY AND IN ORDER TO PROVIDE A COMPLETE DUST
- FREE ENVIRONMENT.
- 8. PROTECT EXISTING STRUCTURES AND UTILITIES WHICH ARE NOT TO BE
- DEMOLISHED.
- 9. PREVENT MOVEMENT AND SETTLEMENT OF ADJACENT STRUCTURES, PROVIDE BRACING AND SHORING AS NECESSARY.
- 10. MARK LOCATION OF UTILITIES. 11. CEASE OPERATIONS IMMEDIATELY IF ADJACENT STRUCTURES APPEAR TO BE IN
- DANGER. NOTIFY ENGINEER BEFORE PROCEEDING. 12. DO NOT INTERFERE WITH NORMAL BUSINESS ACTIVITIES. 13. CONTRACTOR TO FOLLOW 2019 CFC CHAPTER 33 FIRE SAFETY DURING CONSTRUCTION & DEMOLITION FOR THE DURATION OF THE PROJECT. PLEASE CORRECT AS NEEDED AND PROVIDE CONSISTENCY THROUGHOUT (2019 CFC,

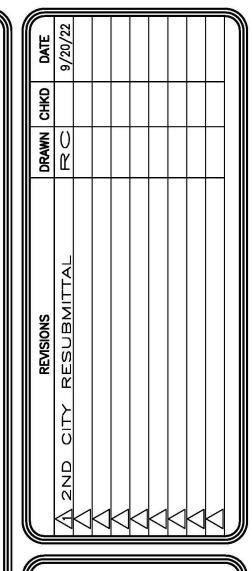

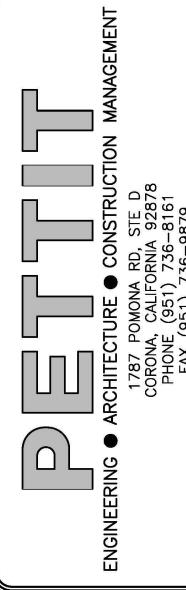



OWNER/CLIENT CITY OF CORONA 400 S. VICENTIA AVE

CORONA, CA 92882

PROJECT TITLE

CORONA FIRE DEPT BLDG . 2ND FLOOR T.I. 735 PUBLIC SAFETY WAY CORONA, CA 92878


DEMOLITION PLANS

SHEET TITLE

8/13/22 DRAWN CHECKED JOB NO. SCALE AS SHOWN DRAWING No. 22-044

D-1

REV.

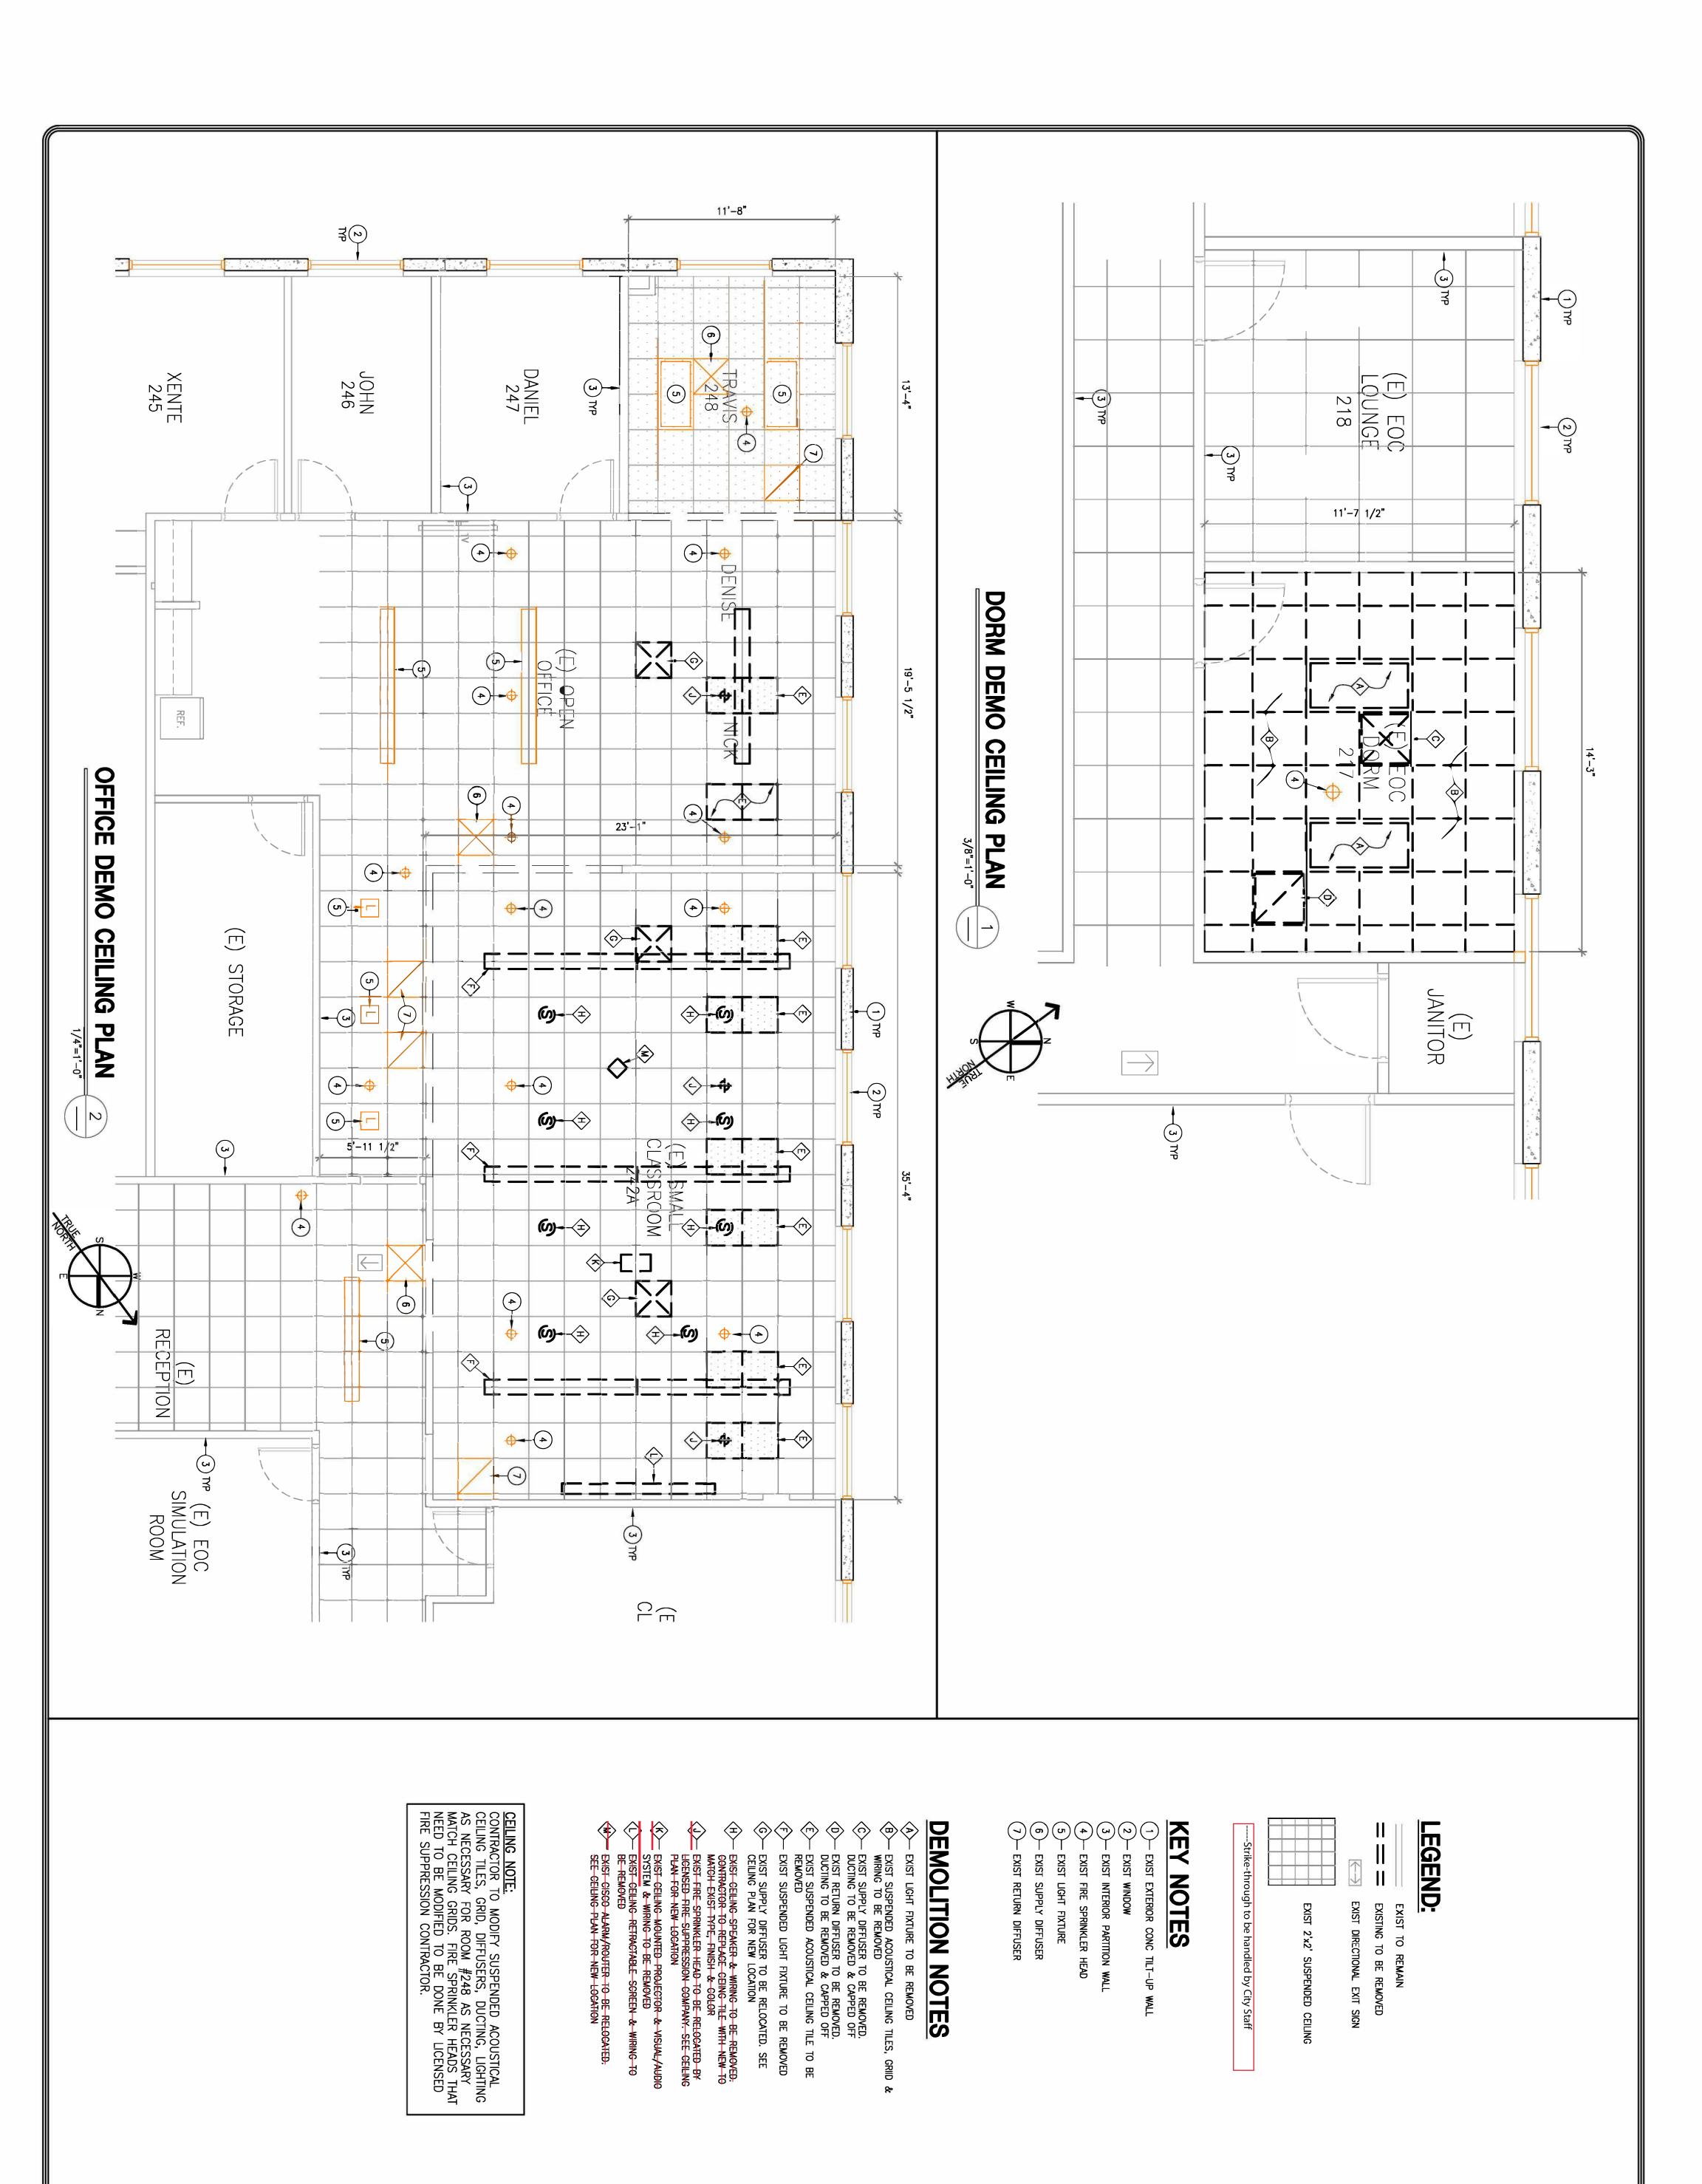


DATE 8/13/22
DRAWN RC
CHECKED
JOB NO. 22027
SCALE AS SHOWN
DRAWING No. 22-050


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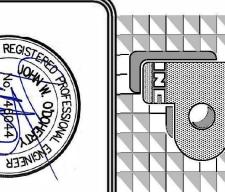
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REV. 00




DEMOLITION CEILING PLANS

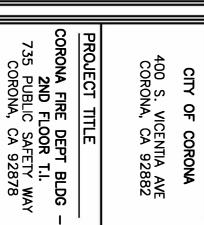




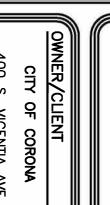

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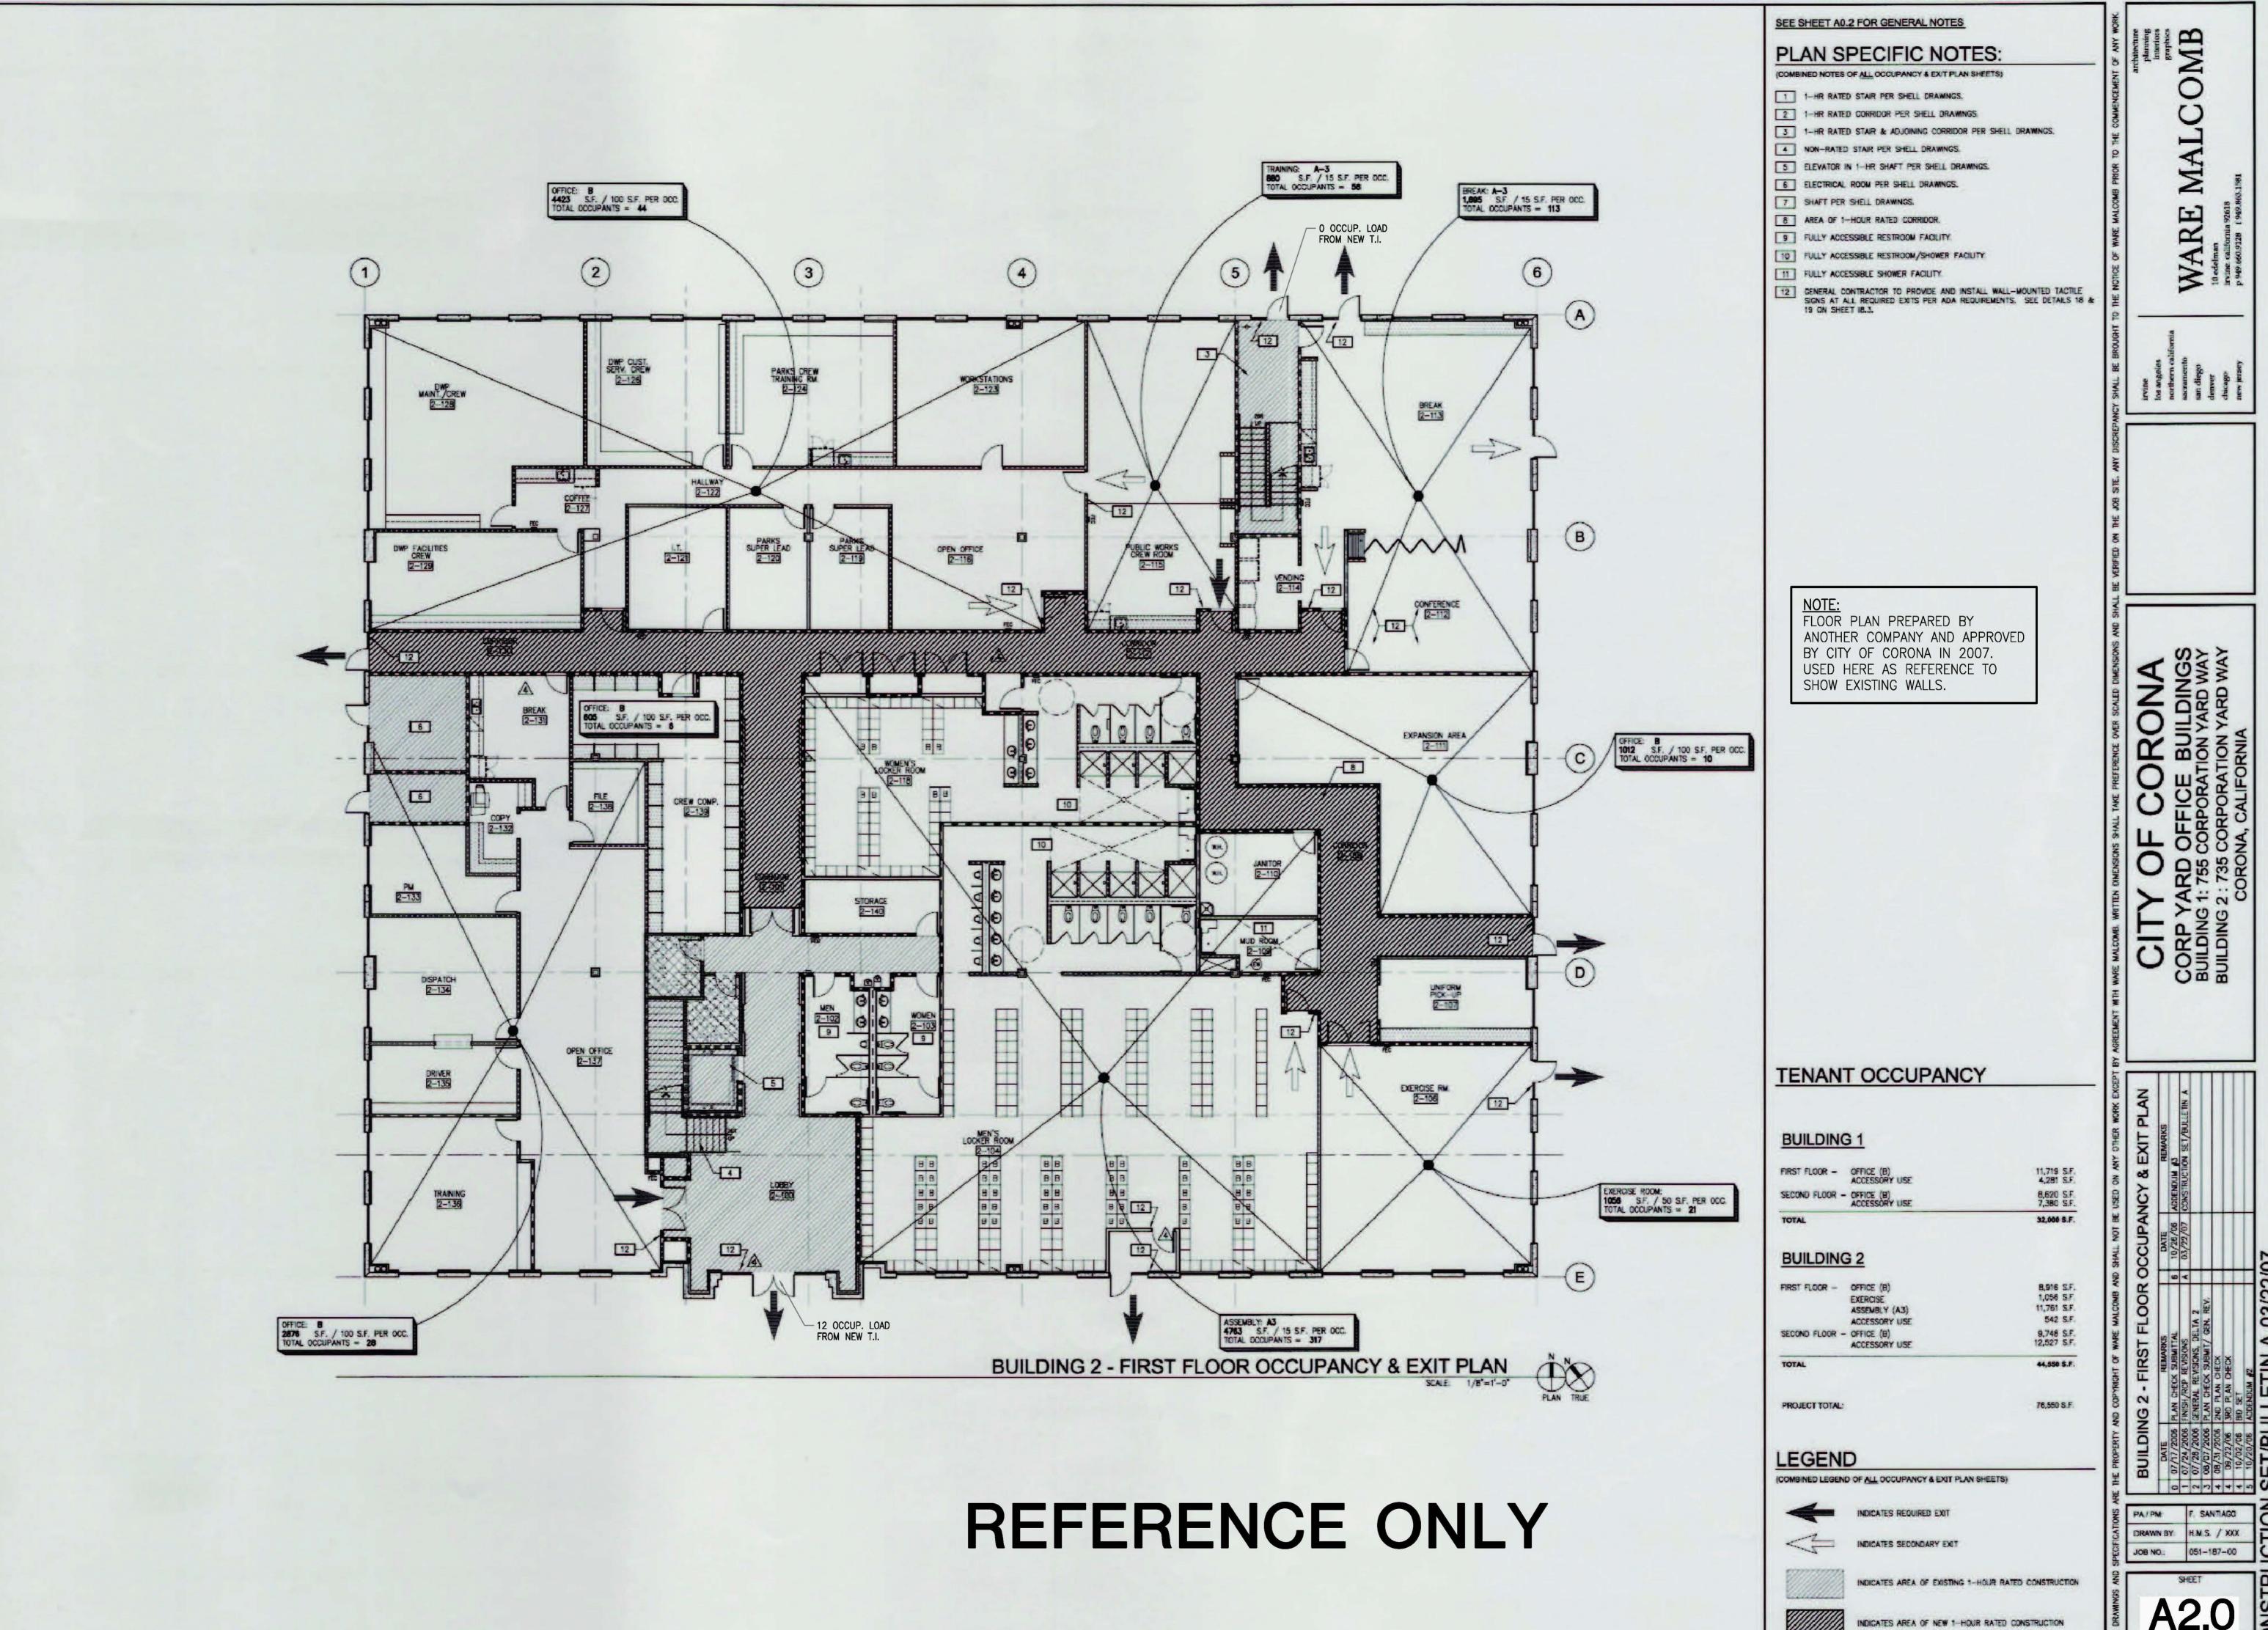


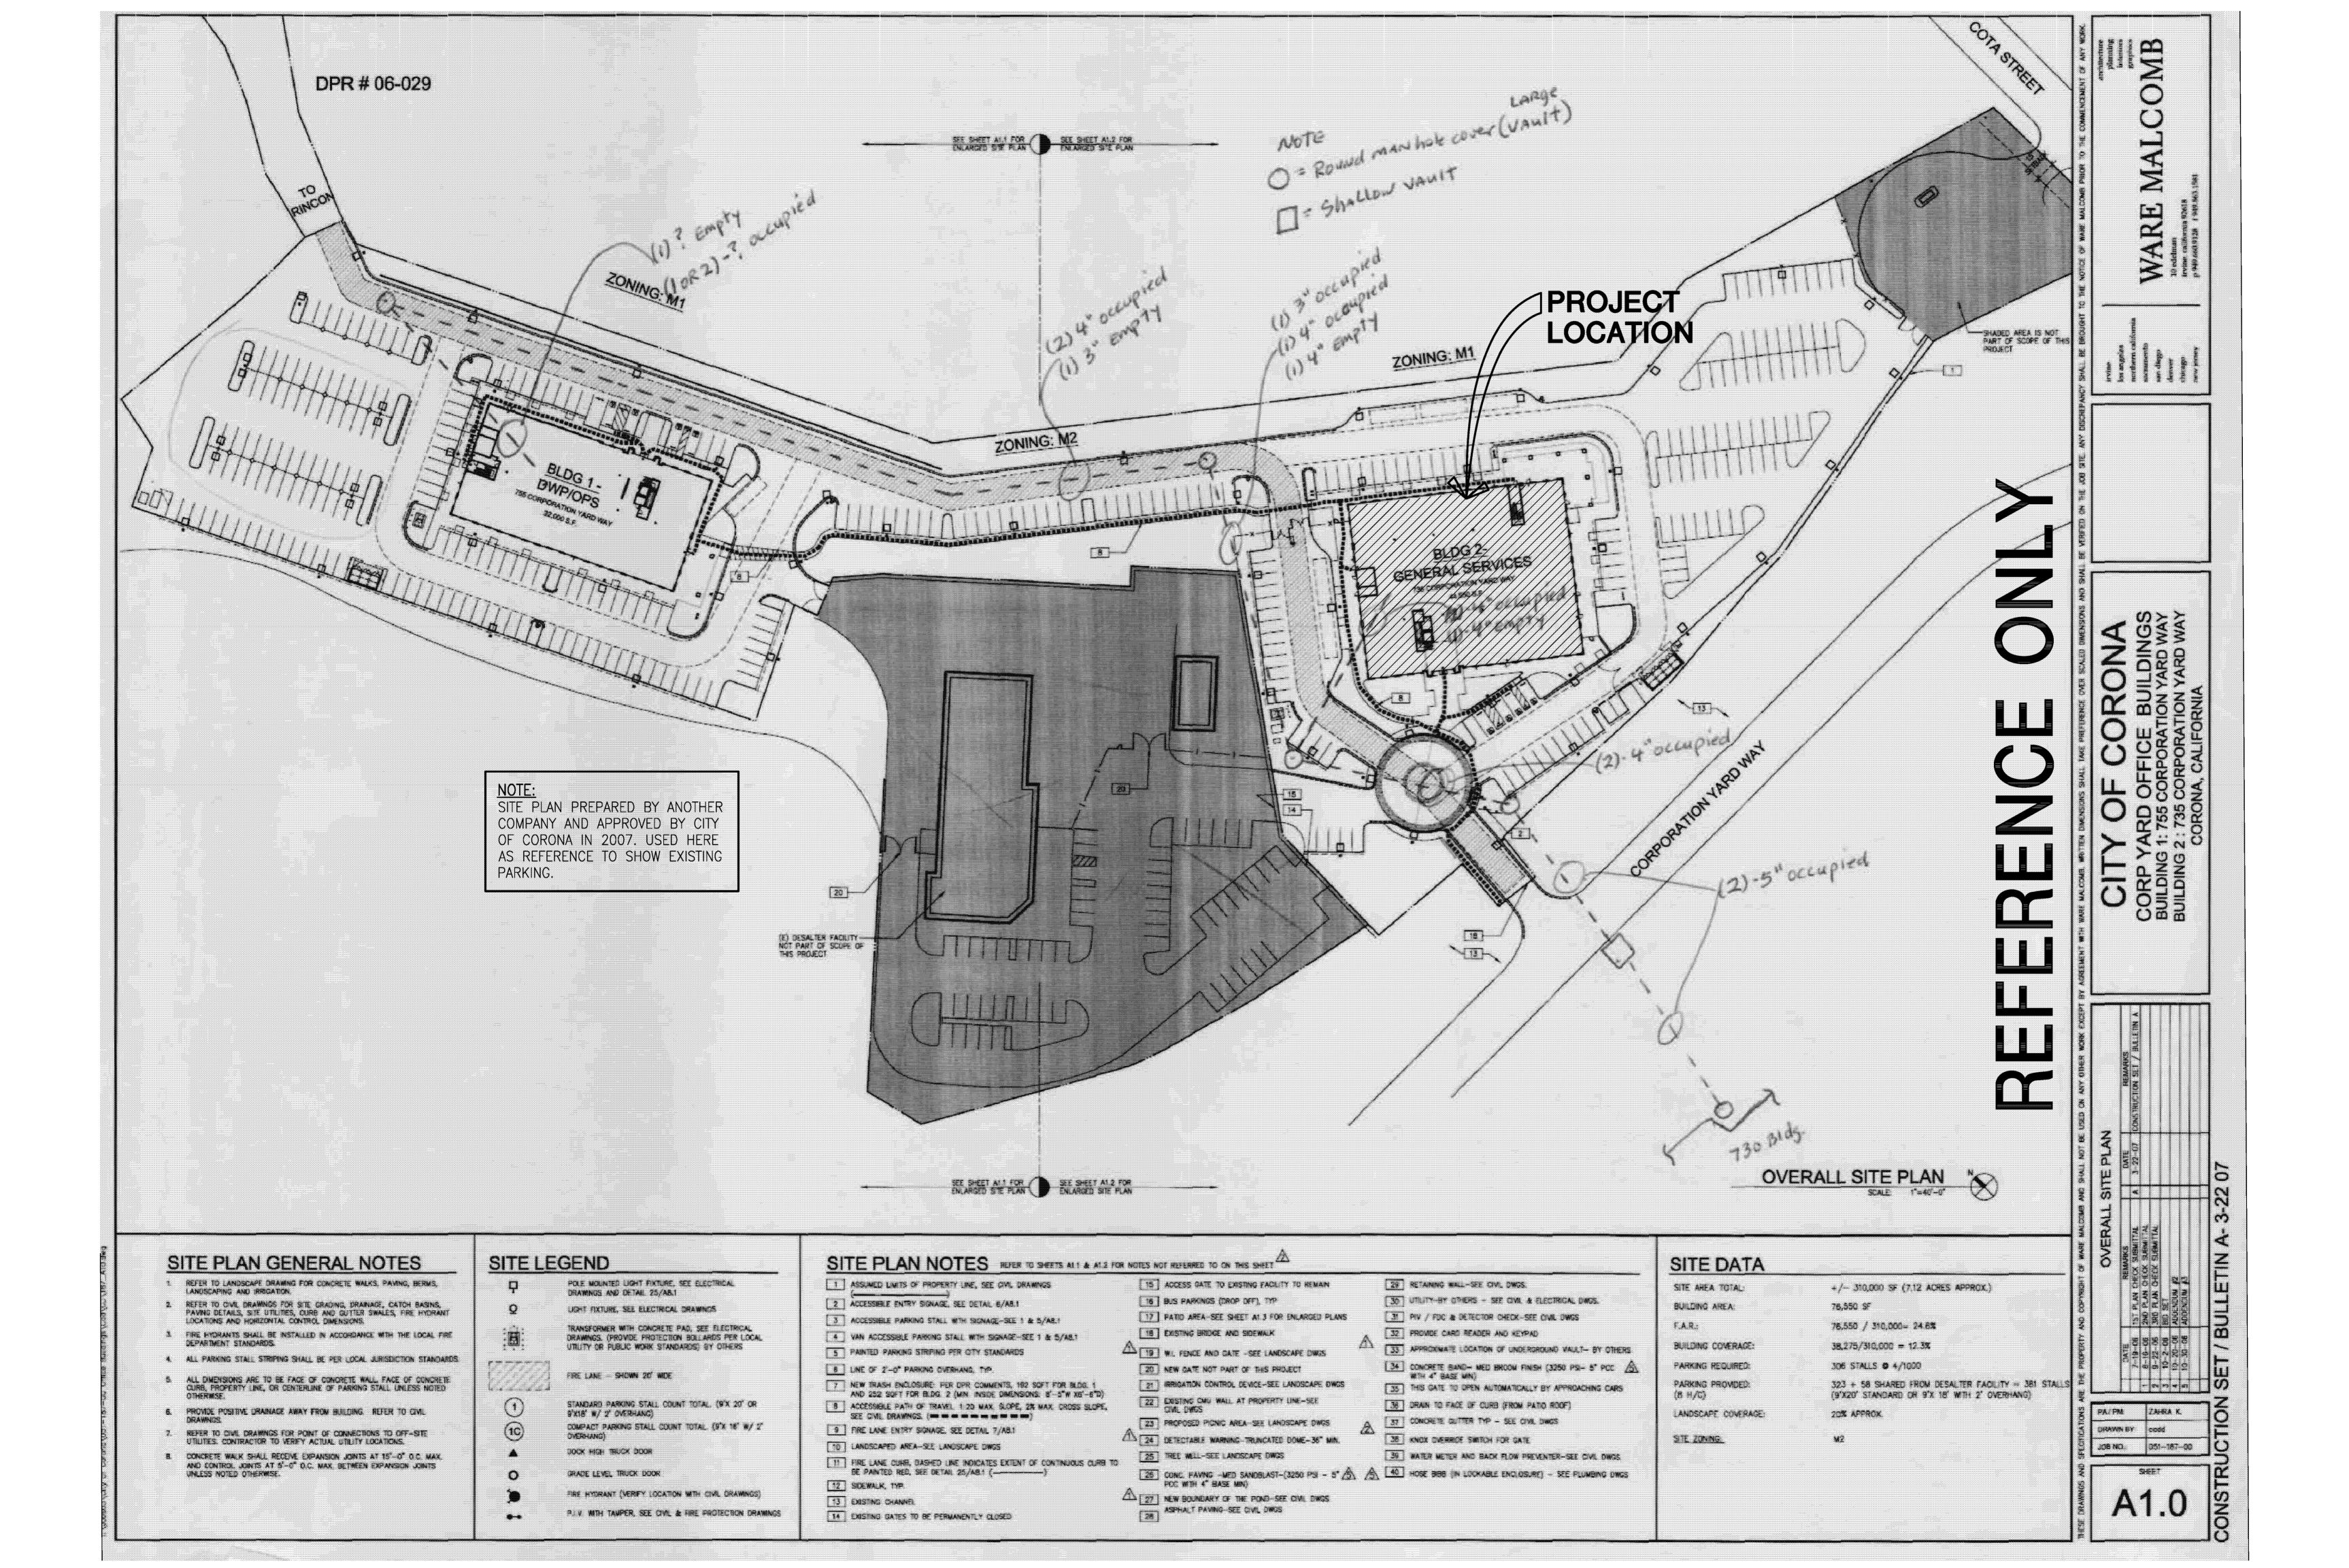


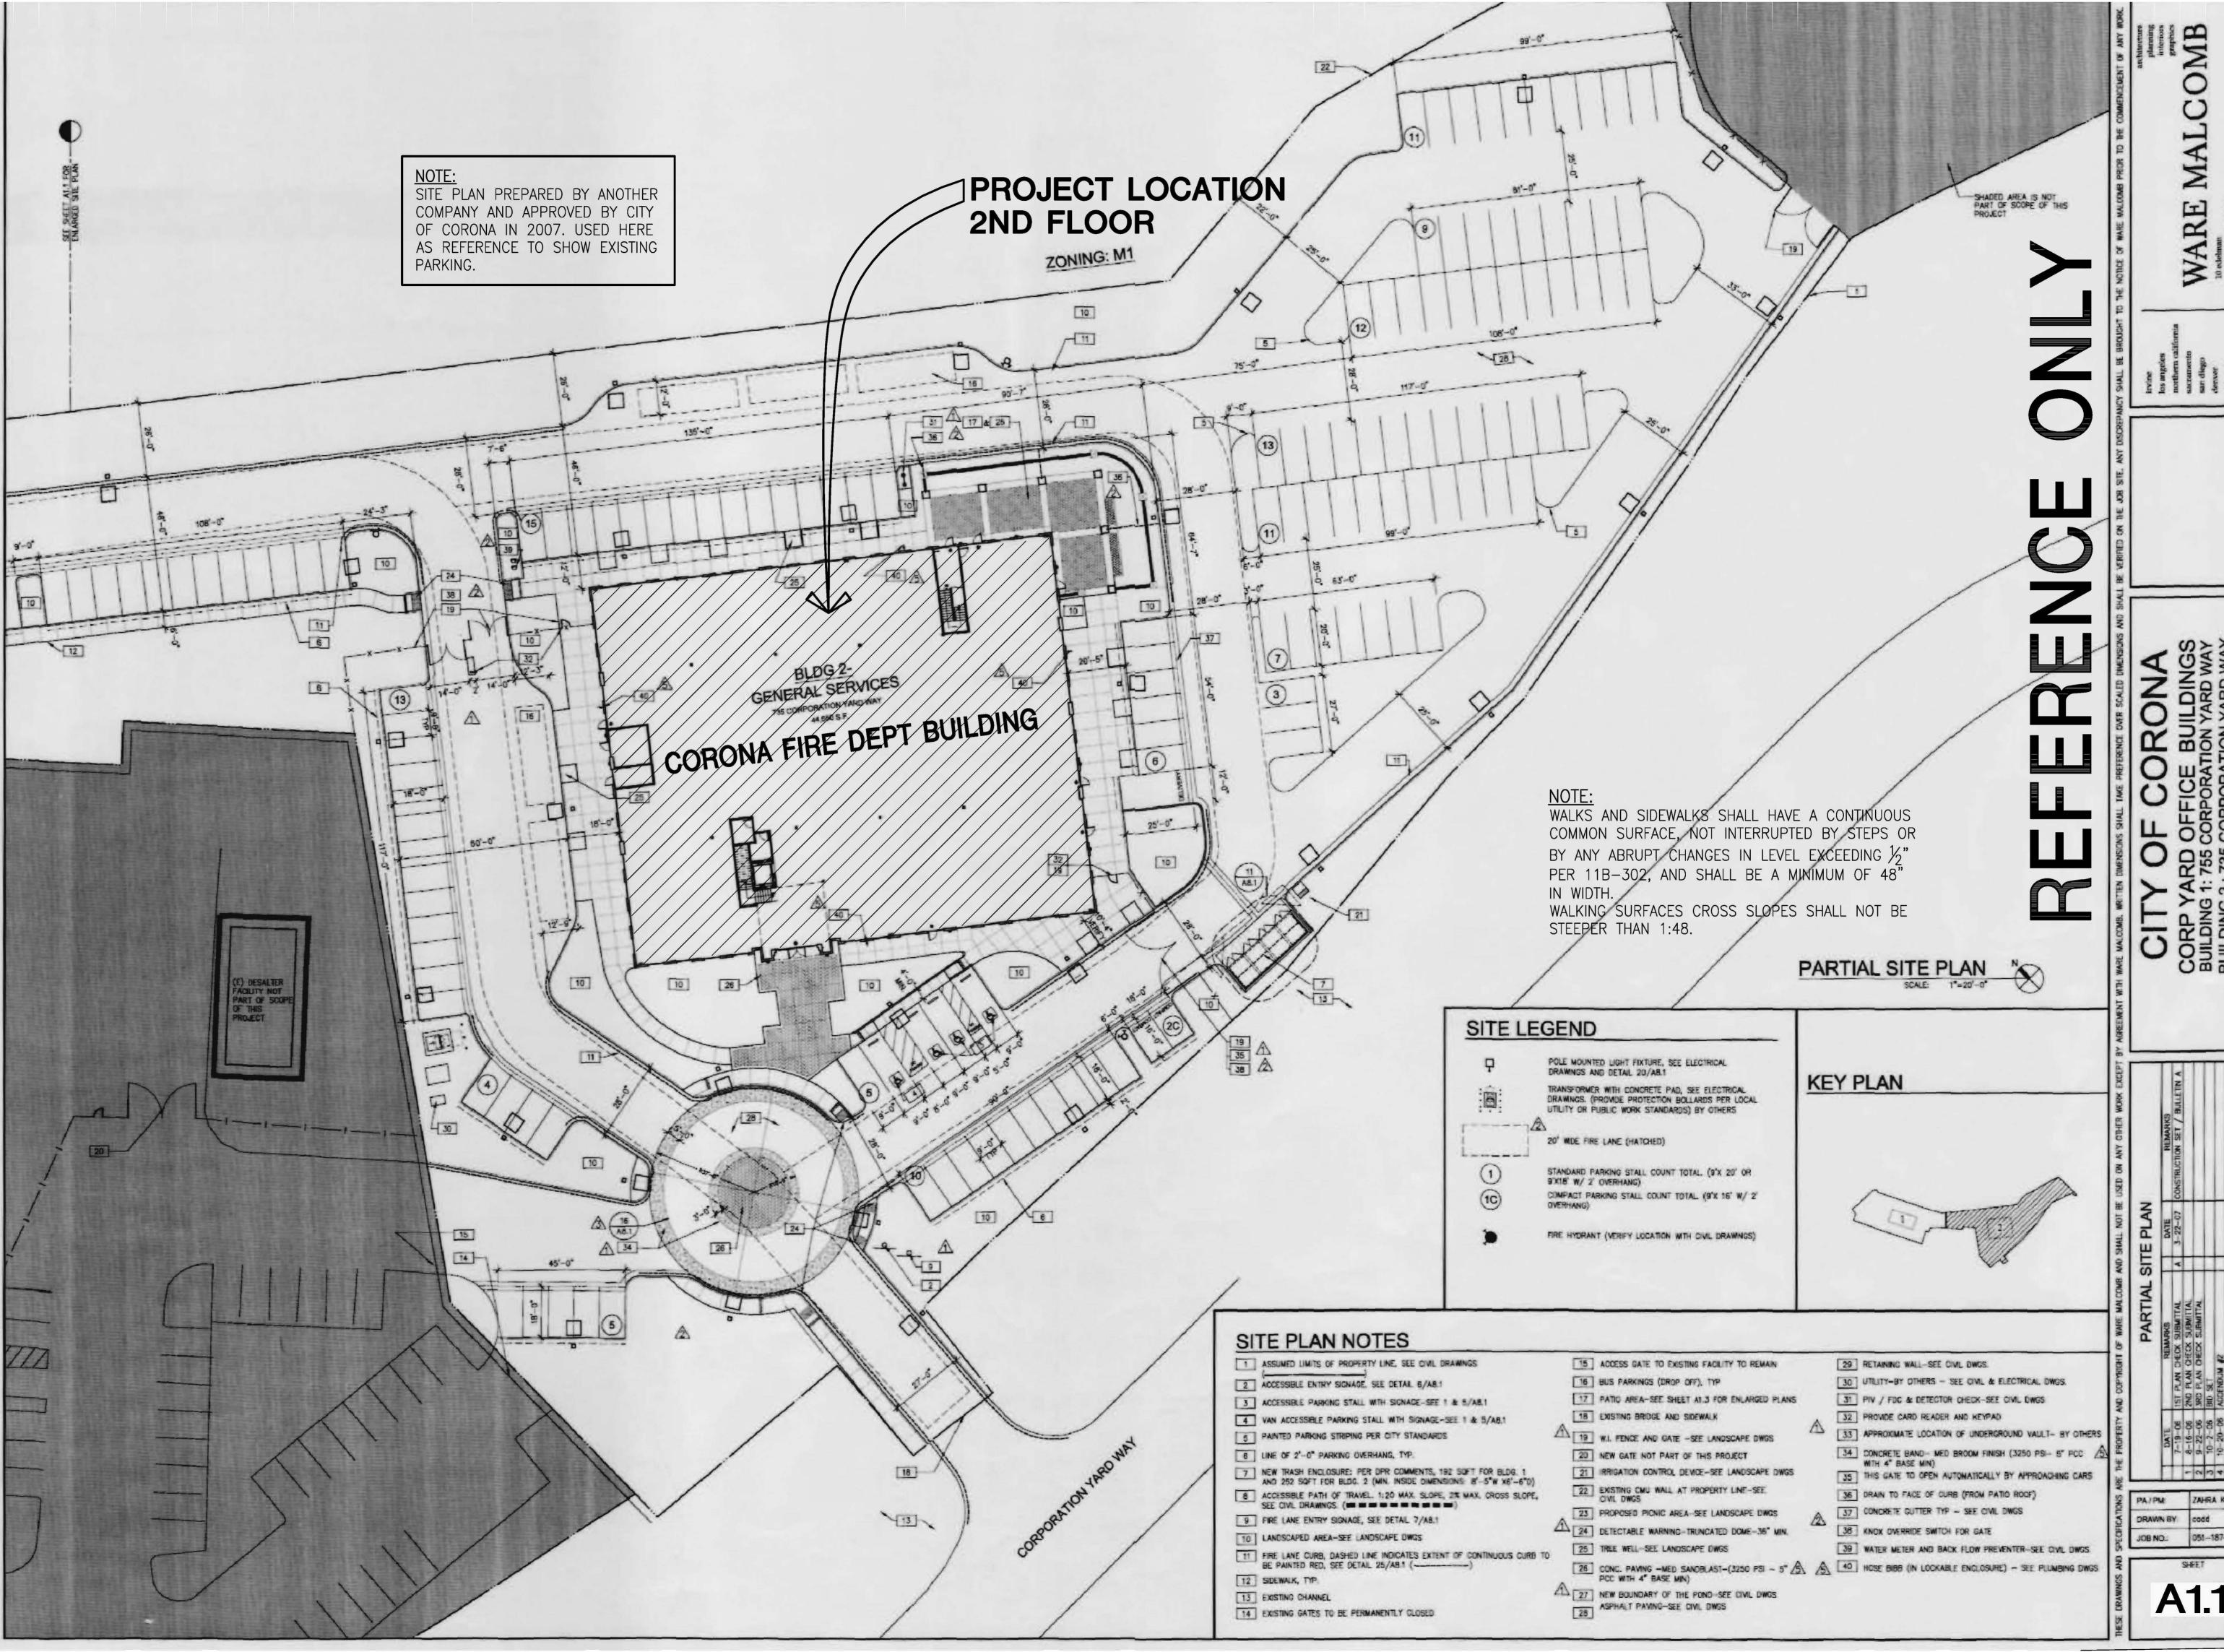ZAHRA K.

JOB NO.: 051-187-00

A1.1



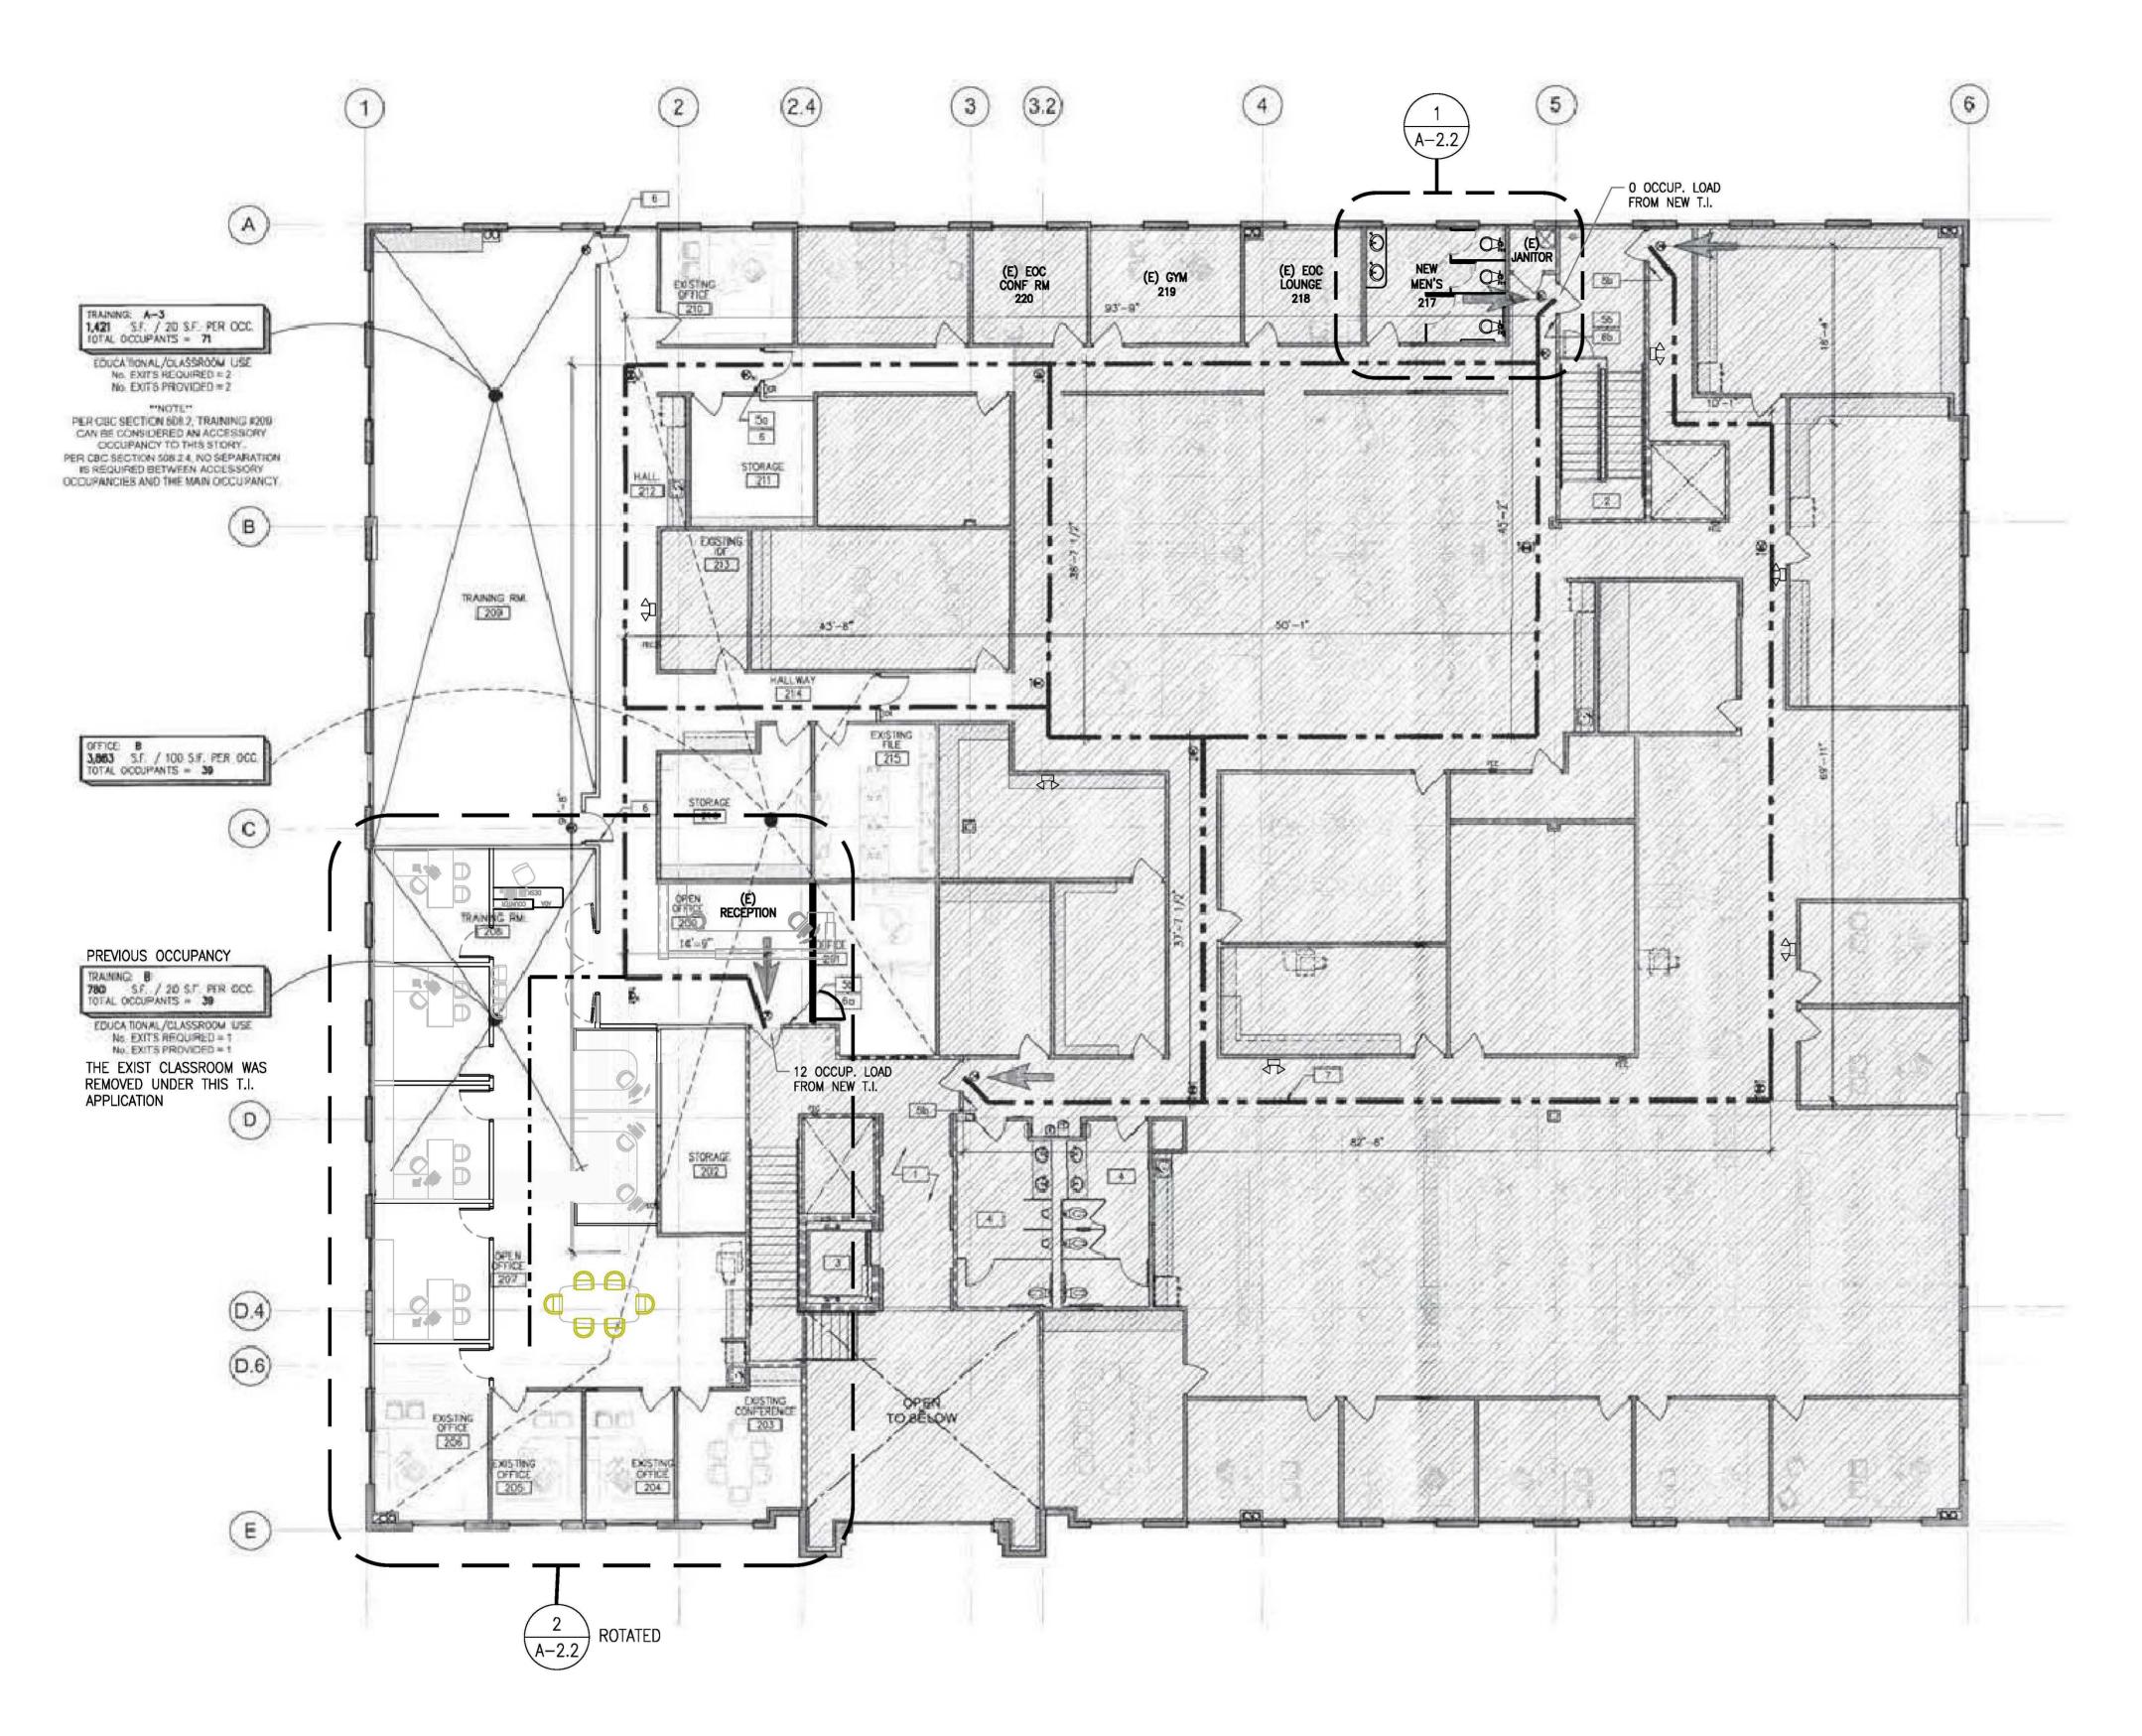

OVERALL 2ND FLOOR PLAN OVERALL OCCUPANCY & EXIT PLAN
SCALE: 1/8"-1"-0" SEE SHEET AD 2 FOR GENERAL NOTES RELATING TO DOORS

PLAN SPECIFIC NOTES

- 1 EXISTING 1-HR RATED ELEVATOR LOBBY WITH STAIR TO REMAIN.
- 2 EXISTING 1-HR RATED STAR TO REMAIN.
- 3 EXISTING ELEVATOR IN 1-HR SHAFT TO REMAIN,
- A EXISTING FULLY ACCESSIBLE RESTROOM FACULTY.
- 5 DENERAL CONTRACTOR TO PROVIDE AND INSTALL WALL -MOUNTED TACTLE SIGN AT LOCATIONS INDICATED IF NONE EXISTING. SEE DETAILS 1 & 4 ON SHEET AO.3.

 a) "EXIT ROUTE".
 b) "EXIT STAIR DOWN"
- 6 THIS DOOR TO HAVE PANIC HARDWARE.

 a) PROVIDE NEW PANIC HARDWARE (SEE DOOR SCHEDULE)

 b) EXISTING PANIC HARDWARE TO REMAIN
- 7 HEAVY DASHED LINE INDICATES PATH OF TRAVEL TO EXIT(S).

RE



FLOOR PLAN PREPARED BY ANOTHER COMPANY AND APPROVED BY CITY OF CORONA IN 2007. USED HERE AS REFERENCE TO SHOW EXISTING WALLS.

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N. TELLO

HEE12-6010-00

LEGEND




INDICATES REQUIRED EXIT

EXISTING EMERGENCY LIGHT UNIT (BUG-EYES)



INDICATES THE EXTINGUISHER CABINET AND EXTINGUISHER

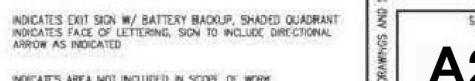


PA/PM

DRAWN BY

JOB NO.

A2.1 INDICATES AREA NOT INCLUDED IN SCOPE OF WORK

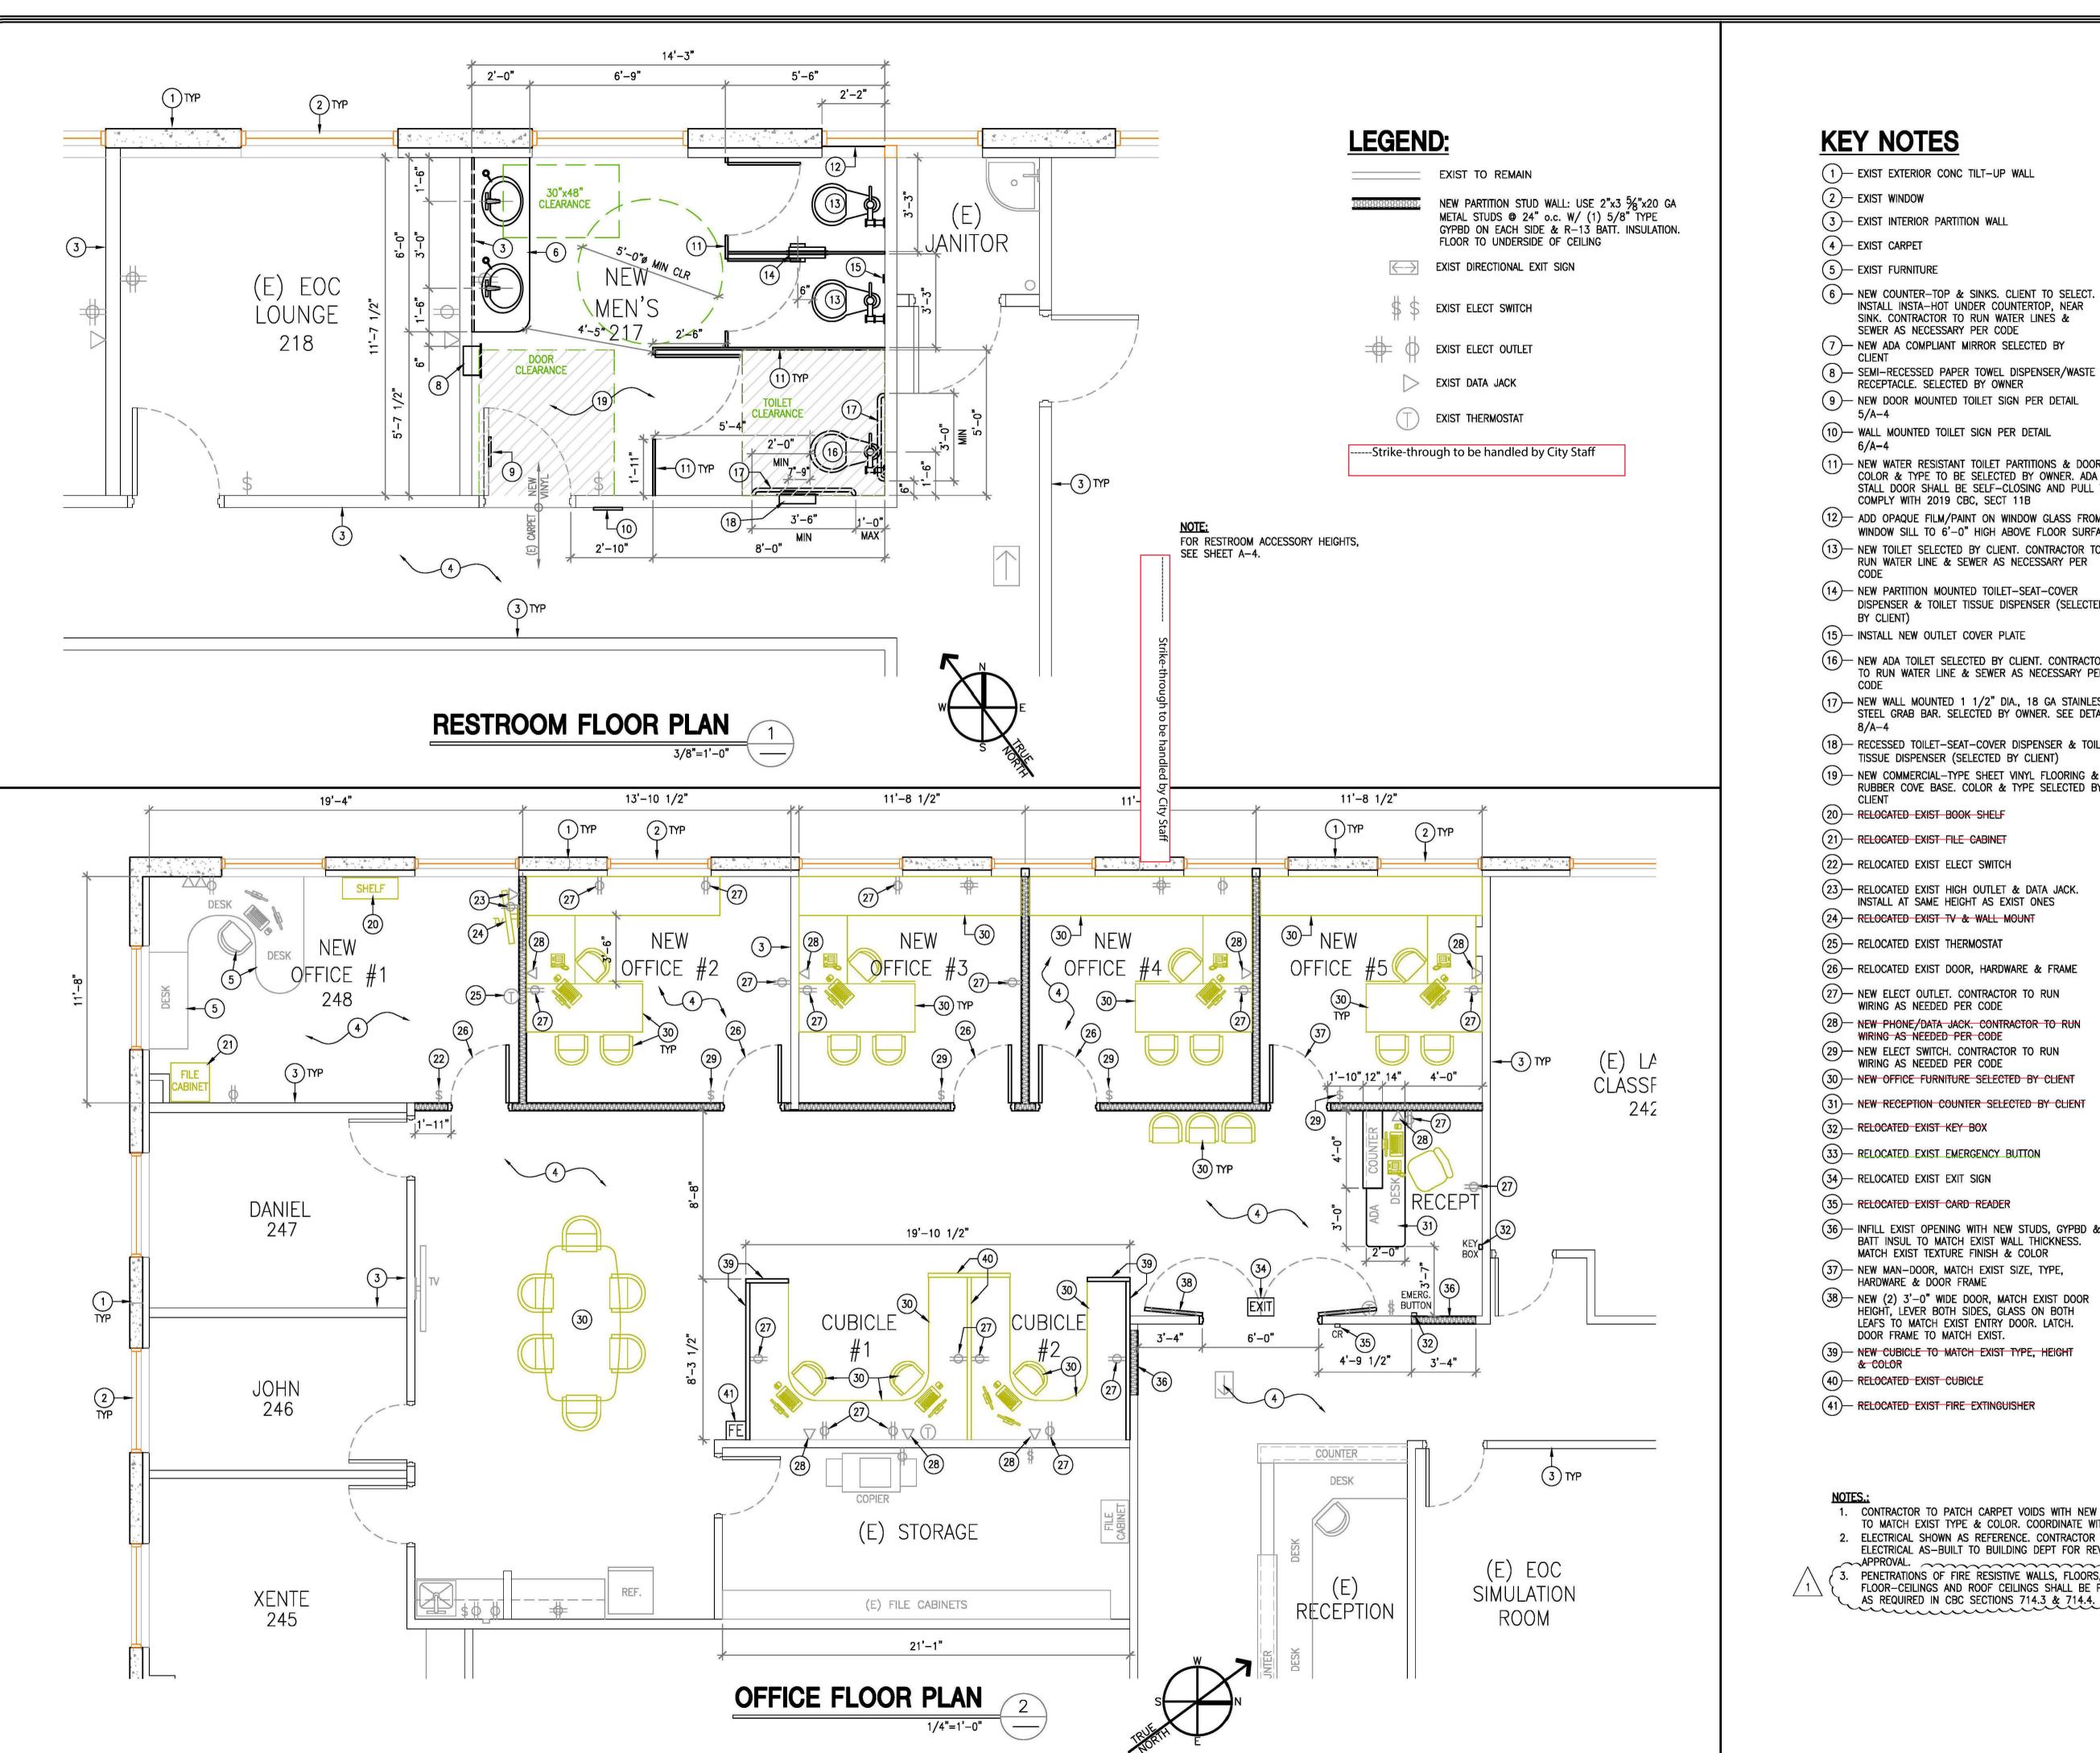


- 6 NEW COUNTER-TOP & SINKS. CLIENT TO SELECT. INSTALL INSTA-HOT UNDER COUNTERTOP, NEAR SINK. CONTRACTOR TO RUN WATER LINES &
- 7 NEW ADA COMPLIANT MIRROR SELECTED BY
- 9 NEW DOOR MOUNTED TOILET SIGN PER DETAIL
- 11)— NEW WATER RESISTANT TOILET PARTITIONS & DOORS. COLOR & TYPE TO BE SELECTED BY OWNER. ADA STALL DOOR SHALL BE SELF-CLOSING AND PULL TO COMPLY WITH 2019 CBC, SECT 11B
- (12)— ADD OPAQUE FILM/PAINT ON WINDOW GLASS FROM WINDOW SILL TO 6'-0" HIGH ABOVE FLOOR SURFACE
- 13 NEW TOILET SELECTED BY CLIENT. CONTRACTOR TO RUN WATER LINE & SEWER AS NECESSARY PER
- 14)— NEW PARTITION MOUNTED TOILET-SEAT-COVER DISPENSER & TOILET TISSUE DISPENSER (SELECTED
- 16 NEW ADA TOILET SELECTED BY CLIENT. CONTRACTOR TO RUN WATER LINE & SEWER AS NECESSARY PER
- 17 NEW WALL MOUNTED 1 1/2" DIA., 18 GA STAINLESS STEEL GRAB BAR. SELECTED BY OWNER. SEE DETAIL
- 18 RECESSED TOILET-SEAT-COVER DISPENSER & TOILET
- (19)— NEW COMMERCIAL-TYPE SHEET VINYL FLOORING & RUBBER COVE BASE. COLOR & TYPE SELECTED BY
- 23— RELOCATED EXIST HIGH OUTLET & DATA JACK.
- (26)— RELOCATED EXIST DOOR, HARDWARE & FRAME

- (36)— INFILL EXIST OPENING WITH NEW STUDS, GYPBD & BATT INSUL TO MATCH EXIST WALL THICKNESS.
 MATCH EXIST TEXTURE FINISH & COLOR
- 38— NEW (2) 3'-0" WIDE DOOR, MATCH EXIST DOOR HEIGHT, LEVER BOTH SIDES, GLASS ON BOTH LEAFS TO MATCH EXIST ENTRY DOOR. LATCH.
- 39 NEW CUBICLE TO MATCH EXIST TYPE, HEIGHT
- 1. CONTRACTOR TO PATCH CARPET VOIDS WITH NEW CARPET TO MATCH EXIST TYPE & COLOR. COORDINATE WITH CLIENT.
- ELECTRICAL SHOWN AS REFERENCE. CONTRACTOR TO SUBMIT ELECTRICAL AS—BUILT TO BUILDING DEPT FOR REVIEW &

APPROVAL.

PENETRATIONS OF FIRE RESISTIVE WALLS, FLOORS,
FLOOR—CEILINGS AND ROOF CEILINGS SHALL BE PROTECTED AS REQUIRED IN CBC SECTIONS 714.3 & 714.4.

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OWNER/CLIENT CITY OF CORONA

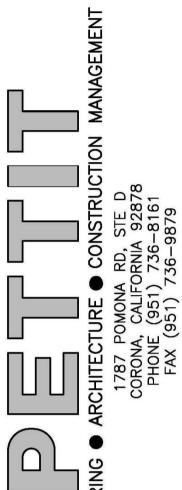PROJECT TITLE CORONA FIRE DEPT BLDG -2ND FLOOR T.I. 735 PUBLIC SAFETY WAY

CORONA, CA 92878


FLOOR PLANS

400 S. VICENTIA AVE CORONA, CA 92882

SHEET TITLE

8/13/22 **DRAWN** CHECKED JOB NO. AS SHOWN DRAWING No. 22-045

> A-2.2REV. 01

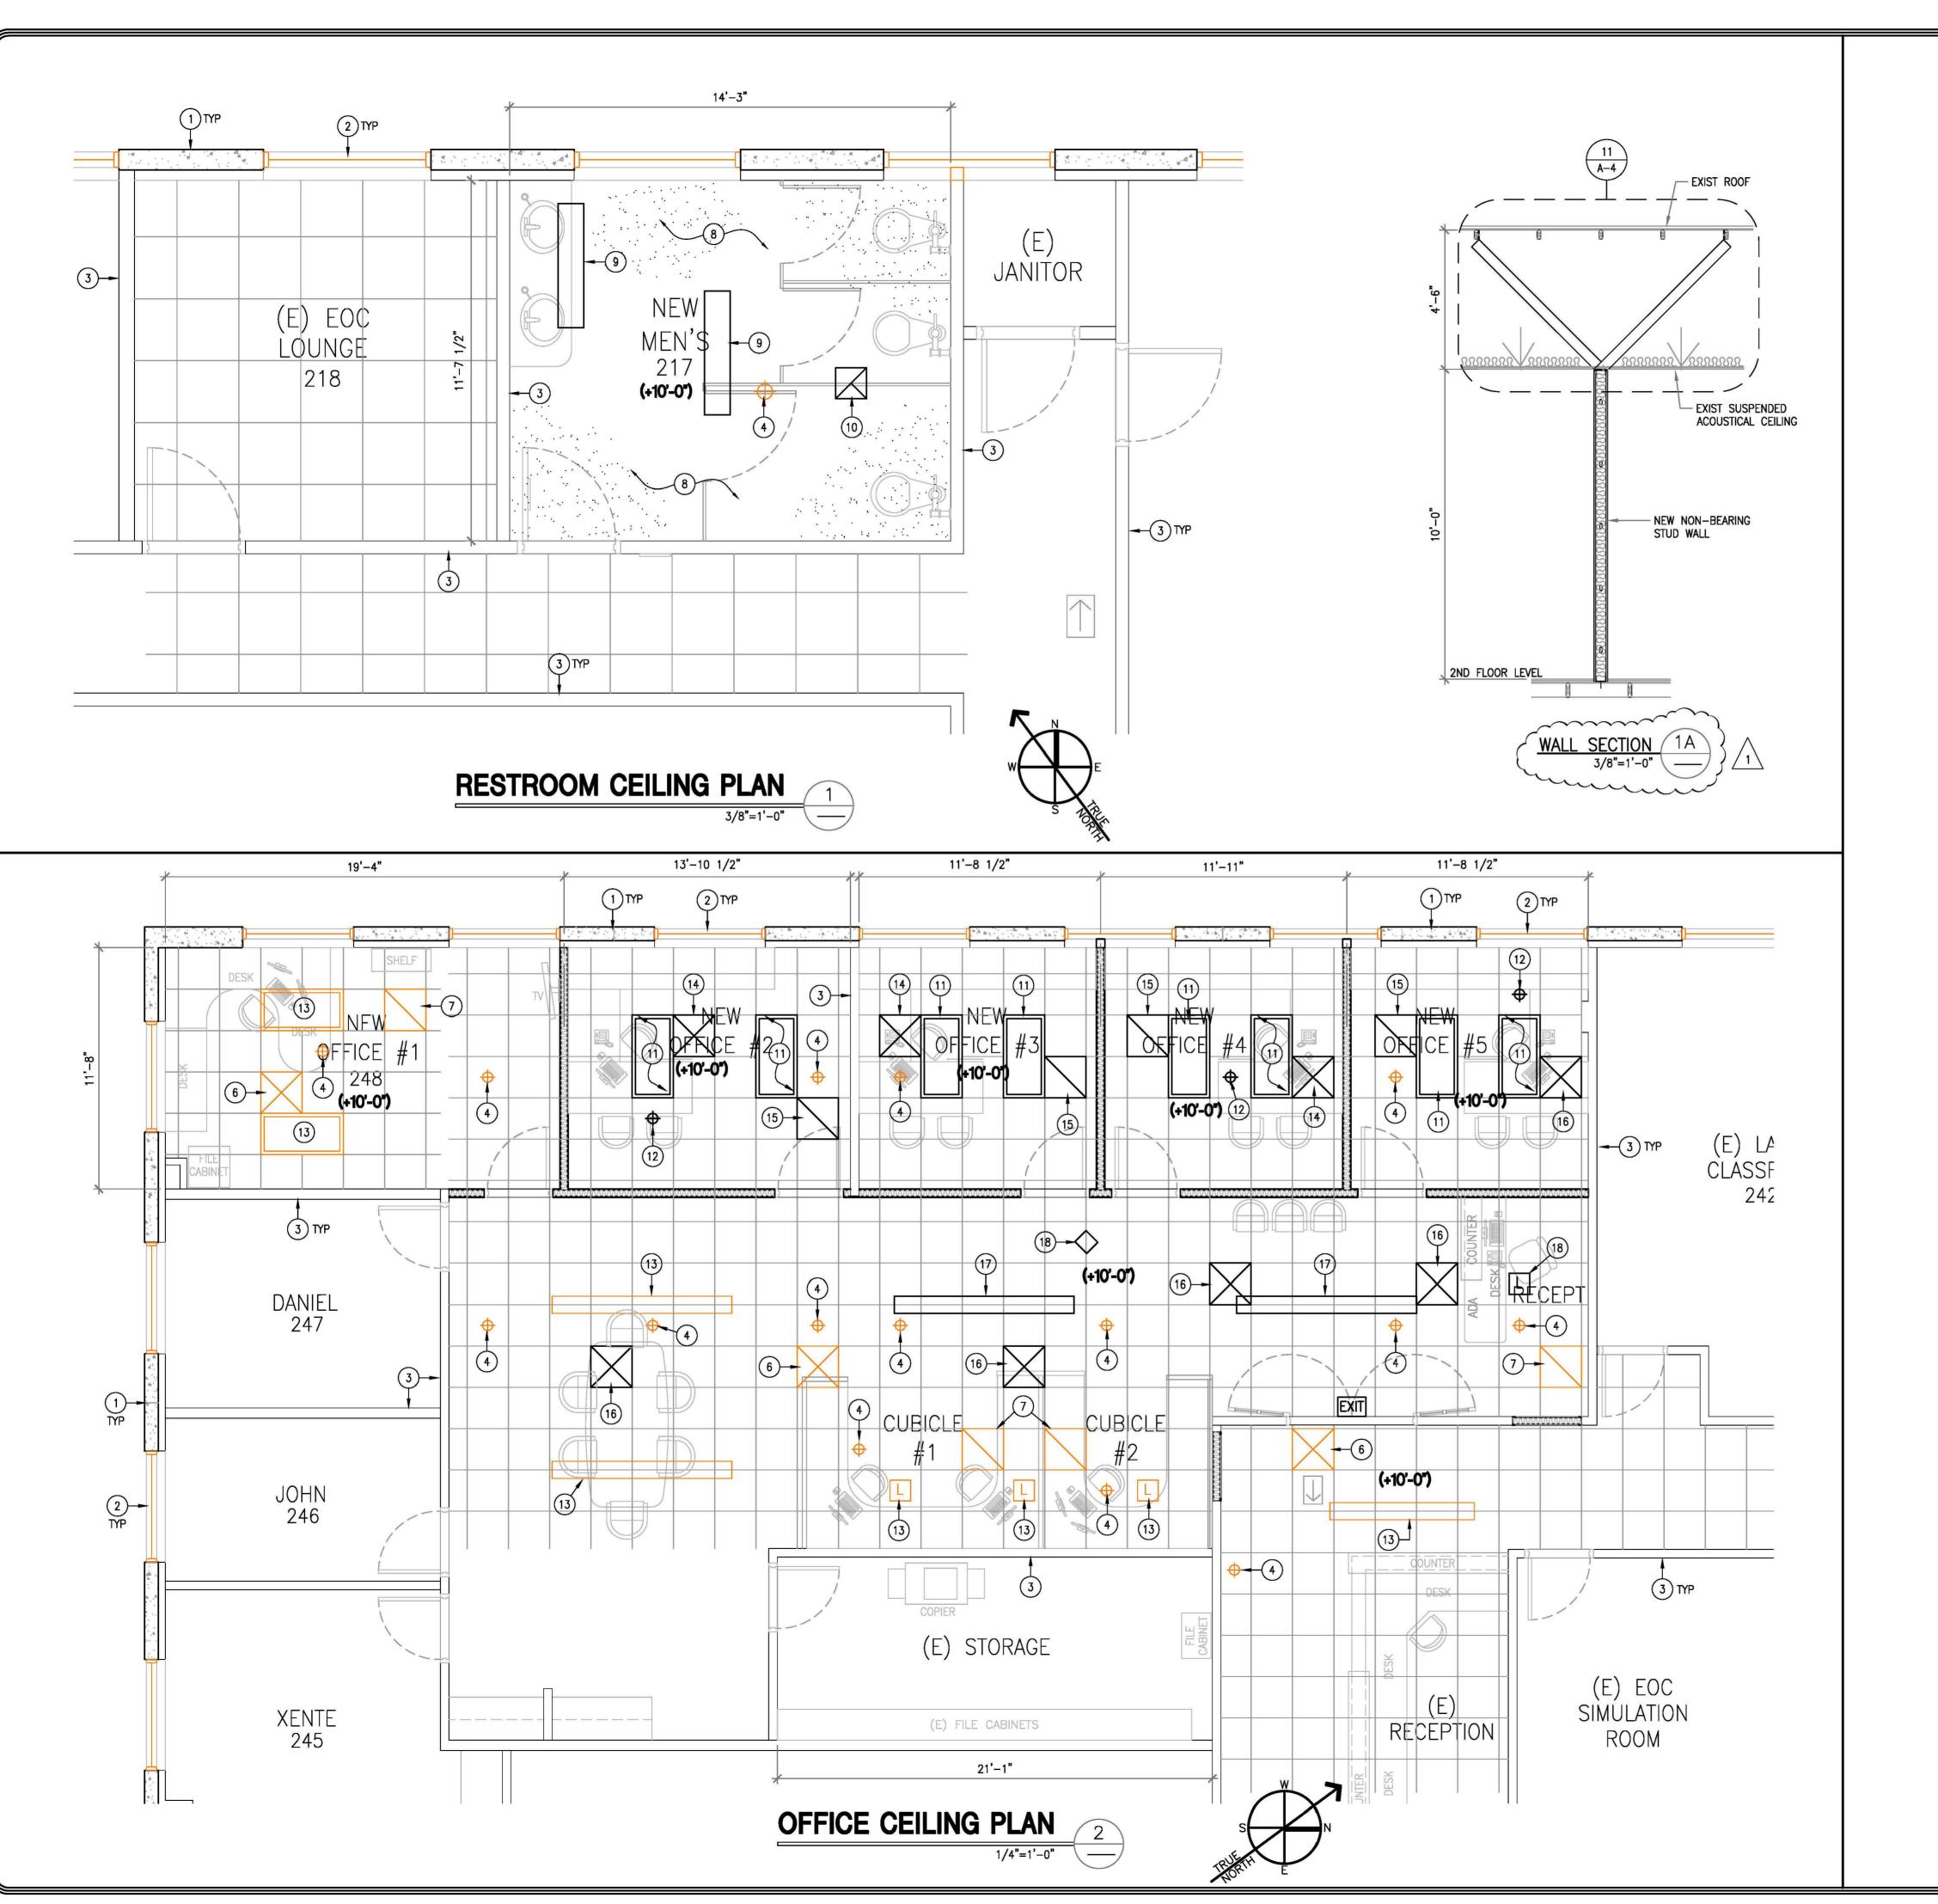


LEGEND:

EXIST TO REMAIN

NEW PARTITION STUD WALL. CONTRACTOR TO ADD 2x DIAGONAL BRACING. SEE DETAIL 11/SHT A-4

EXIST DIRECTIONAL EXIT SIGN

RELOCATED LIGHTED EXIT SIGN

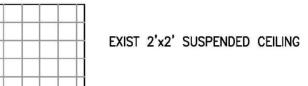

(+X'-X") = CEILING HEIGHT

-----Strike-through to be handled by City Staff

KEY NOTES


- 1)— EXIST EXTERIOR CONC TILT-UP WALL
- 2 EXIST WINDOW
- (3)— EXIST INTERIOR PARTITION WALL
- (4)— EXIST FIRE SPRINKLER HEAD
- 5 EXIST CEILING SPEAKER
- 6 EXIST SUPPLY DIFFUSER
- (7)— EXIST RETURN DIFFUSER
- 8 NEW SOLID CEILING: USE 5/8" THK GYPB ATTACHED TO NEW 2x CEILING JOISTS. TEXTURE FINISH & COLOR SELECTED BY CLIENT
- 9 NEW CEILING MOUNTED LIGHT FIXTURE SELECTED BY CLIENT. CONTRACTOR TO RUN CONDUIT/WIRING TO NEW FIXTURES PER CODE
- 10 NEW BATHROOM EXHAUST FAN WITH BDD & ROOF/WALL CAP (SELECTED BY CLIENT). CONTRACTOR TO RUN POWER & EXHAUST PER CODE. INTERLOCK WITH LIGHT SWITCH
- (11)— NEW LIGHT FIXTURE SELECTED BY CLIENT. CONTRACTOR TO RUN CONDUIT/WIRING TO NEW FIXTURES PER CODE
- 12 RELOCATED EXIST SPRINKLER HEAD TO BE DONE BY LICENSED FIRE SUPPRESSION COMPANY
- 13 EXIST LIGHT FIXTURE
- 14)— RELOCATED EXIST SUPPLY DIFFUSER. CONTRACTOR TO RUN DUCTING AS NECESSARY
- 15— NEW RETURN DIFFUSER. CONTRACTOR TO RUN DUCTING AS NECESSARY PER CODE
- 16 NEW SUPPLY DIFFUSER. CONTRACTOR TO RUN DUCTING AS NECESSARY PER CODE
- 17)— RELOCATED EXIST RETURN DIFFUSER.
 CONTRACTOR TO RUN DUCTING AS NECESSARY PER CODE
- (18)— RELOCATED EXIST CISCO ALARM/ROUTER.
 CONTRACTOR TO RUN WIRING AS NECESSARY
- 17)— NEW SUSPENDED LIGHT FIXTURE TO MATCH EXIST TYPE. CONTRACTOR TO RUN WIRING AS NECESSARY PER CODE
- 18 NEW SQUARE LIGHT FIXTURE TO MATCH EXIST TYPE. CONTRACTOR TO RUN WIRING AS NECESSARY PER CODE


CEILING NOTE:

CONTRACTOR TO MODIFY SUSPENDED ACOUSTICAL CEILING TILES, DIFFUSERS, DUCTING, LIGHTING AS NECESSARY FOR NEW WALLS & ROOMS. FIRE SPRINKLER HEADS THAT NEED TO BE MODIFIED TO BE DONE BY LICENSED FIRE SUPPRESSION CONTRACTOR.

GENRAL NOTE:

ELECTRICAL & MECHANICAL SHOWN AS REFERENCE. CONTRACTOR TO SUBMIT ELECTRICAL & MECHANICAL AS-BUILTS TO BUILDING DEPT FOR REVIEW & APPROVAL.

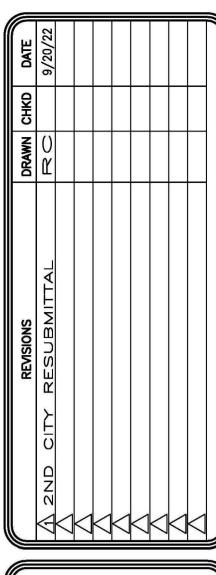

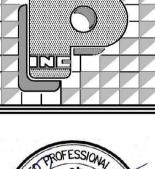



OWNER/CLIENT CITY OF CORONA

400 S. VICENTIA AVE CORONA, CA 92882

PROJECT TITLE

CORONA FIRE DEPT BLDG 2ND FLOOR T.I. 735 PUBLIC SAFETY WAY CORONA, CA 92878

SHEET TITLE

REFLECTED CEILING PLANS

DATE	8/13/22
DRAWN	RC
CHECKED	1
JOB NO.	22027
SCALE	AS SHOWN
DRAWING	No. 22-051
	A-3

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REV.

