

PROJECT: SPRINT RIVERSIDE NSB

SITE NAME: **KELLOG PARK**

SITE CASCADE: **RV77XC011**

1635 KELLOGG AVENUE SITE ADDRESS: **CORONA, CA 91718**

MONOPINE SITE TYPE:

SITE INFORMATION **AREA MAP** PROJECT DESCRIPTION **DRAWING INDEX** REV ENG SHEET NO: PROPERTY OWNER: SHEET TITLE SPRINT NEW SITE BUILD ADD: CITY OF CORONA TITLE SHEET & PROJECT DATA PO BOX 940 PROPOSED (12) SPRINT PANEL ANTENNAS MOUNTED TO CORONA, CA 92878 PROPOSED MONOPINE. SITE ID: RV77XC011 GENERAL NOTES 0 PROPOSED (18) SPRINT RRHs. GENERAL NOTES 0 LATITUDE (NAD83): **CONSTRUCTION TYPE:** PROPOSED (4) SPRINT EQUIPMENT CABINETS. (GOOGLE EARTH) SPRINT SPECIFICATIONS 0 PROPOSED SPRINT PPC AND TELCO CABINETS. SPRINT SPECIFICATIONS **ZONING JURISDICTION:** 0 33.8639° CITY OF CORONA PROPOSED SPRINT METER LONGITUDE (NAD83): TOPOGRAPHIC SURVEY ZONING CLASSIFICATION: (GOOGLE EARTH) PROPOSED SPRINT GPS ANTENNA. 2 LS-2 TOPOGRAPHIC SURVEY 117° 33' 27.75" W OVERALL SITE PLAN 0 PROPOSED 47'-0" HIGH MONOPINE STRUCTURE HEIGHT: ENLARGED SITE PLAN 0 PARCEL NUMBER: INSTALL (6) NEW 1 1/4" HYBRID CABLE. EQUIPMENT AND ANTENNA PLAN A-3 0 111-080-017-5 **POWER COMPANY:** A-4 **ELEVATIONS** 0 **ELEVATIONS** COUNTY: AAV (TELCO) PROVIDER: RIVERSIDE COUNTY **EQUIPMENT SUPPLIER:** OCCUPANCY: B / U-2 **PURCELL & ELTEK** LOCATION MAP **APPLICABLE CODES**

PROJECT TEAM

APPLICANT AGENT:

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SITE ACQUISITION:

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ACCESSIBILITY REQUIREMENTS:

FACILITY IS UNMANNED AND NOT FOR HUMAN HABITATION. HANDICAPPED ACCESS REQUIREMENTS ARE NOT REQUIRED.

CALIFORNIA STATE CODE COMPLIANCE:

2016 CALIFORNIA BUILDING CODE, VOLUMES 1 AND 2 2016 CALIFORNIA RESIDENTIAL CODE

2016 CALIFORNIA HISTORICAL BUILDING CODE 2016 CALIFORNIA FIRE CODE

2016 CALIFORNIA REFERENCED STANDARDS CODE 2016 CALIFORNIA ADMINISTRATIVE CODE

2016 CALIFORNIA EXISTING BUILDING CODE 2016 CALIFORNIA GREEN BUILDING CODE

HE LOCAL JURISDICTION:

2016 CALIFORNIA ELECTRICAL CODE

2016 CALIFORNIA MECHANICAL CODE

2016 CALIFORNIA PLUMBING CODE 2016 CALIFORNIA ENERGY CODE

ALL WORK AND MATERIALS SHALL BE PERFORMED AND INSTALLED IN ACCORDANCE WITH THE CURRENT EDITIONS OF THE CODES AS ADOPTED BY



<u>APPROVAL</u>

SPRINT PROJECT

PRINT ENGINEER

ROPERTY OWNER

SIGNATURE

12657 ALCOSTA BLVD SUITE 300 SAN RAMON, CA 94583

PLANS PREPARED BY



10590 West Ocean Air Dr Suite 300 San Diego, CA 92130 858·964·7439

Md7 PROJECT NUMBER:

DRAW	/N BY:	CHECKED BY:
JC		AF
REV.	DATE:	ISSUED FOR:
A	07/31/2018	90% ZD FOR REVIEW
0	08/17/2018	100% ZD
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All drawings and written material contained herein may not be duplicated, used or disclosed without the written consent of the architect.

SITE INFORMATION SITE NAME

KELLOG PARK

SITE CASCADE: RV77XC011 SITE ADDRESS:

1635 KELLOGG AVENUE

CORONA, CA 91718

SHEET TITLE:

DATE

TITLE SHEET

GENERAL CONSTRUCTION NOTES

- ALL WORK SHALL CONFORM TO THE REQUIREMENTS OF THE LOCAL BUILDING
 CODE, THE LATEST EDITION AND ALL OTHER APPLICABLE CODES AND
 ORDINANCES
- 2. CONTRACTOR SHALL CONSTRUCT SITE IN ACCORDANCE WITH THESE DRAWINGS AND SPRINT INTEGRATED CONSTRUCTION STANDARDS FOR WIRELESS SITES (LATEST REVISION). THE SPECIFICATION IS THE RULING DOCUMENT AND ANY DISCREPANCIES BETWEEN THE SPECIFICATION AND THESE DRAWINGS SHOULD BE BROUGHT TO THE ATTENTION OF THE ENGINEER PRIOR TO PROCEEDING WITH CONSTRUCTION
- 3. CONTRACTOR SHALL VISIT THE JOB SITE AND SHALL FAMILIARIZE HIMSELF WITH ALL CONDITIONS AFFECTING THE NEW WORK AND SHALL MAKE PROVISIONS AS TO THE COST THEREOF. FIELD CONDITIONS AND DIMENSIONS AND CONFIRMING THAT THE WORK MAY BE ACCOMPLISHED AS SHOWN PRIOR TO PROCEEDING WITH CONSTRUCTION. ANY DISCREPANCIES SHALL BE BROUGHT TO THE ATTENTION OF THE ENGINEER PRIOR TO THE COMMENCEMENT OF WORK. NO COMPENSATION WILL BE AWARDED BASED ON CLAIM OF LACK OF KNOWLEDGE OF FIELD CONDITIONS
- 4. PLANS ARE NOT TO BE SCALED. THESE PLANS ARE INTENDED TO BE A DIAGRAMMATIC OUTLINE ONLY UNLESS OTHERWISE NOTED. THE WORK SHALL INCLUDE FURNISHING MATERIALS, EQUIPMENT AND APPURTENANCES, AND LABOR NECESSARY TO EFFECT ALL INSTALLATIONS AS INDICATED ON THE DRAWINGS.
- 5. DIMENSIONS SHOWN ARE TO FINISH SURFACES UNLESS OTHERWISE NOTED. SPACING BETWEEN EQUIPMENT IS REQUIRED CLEARANCE. THEREFORE, IT IS CRITICAL TO FIELD VERIFY DIMENSIONS, SHOULD THERE BE ANY QUESTIONS REGARDING THE CONTRACT DOCUMENTS, EXISTING CONDITIONS AND/OR DESIGN INTENT, THE CONTRACTOR SHALL BE RESPONSIBLE FOR OBTAINING THE WORK
- 6. DETAILS ARE INTENDED TO SHOW DESIGN INTENT. MODIFICATIONS MAY BE REQUIRED TO SUIT JOB DIMENSIONS OR CONDITIONS, AND SUCH MODIFICATIONS SHALL BE INCLUDED AS PART OF THE WORK.
- 7. CONTRACTOR SHALL RECEIVE CLARIFICATION IN WRITING, AND SHALL RECEIVE IN WRITING AUTHORIZATION TO PROCEED BEFORE STARTING WORK ON ANY ITEMS NOT CLEARLY DEFINED OR IDENTIFIED BY THE CONTRACT DOCUMENTS.
- 8. CONTRACTOR SHALL SUPERVISE AND DIRECT THE WORK USING THE BEST CONSTRUCTION SKILLS AND ATTENTION. CONTRACTOR SHALL BE SOLELY RESPONSIBLE FOR CONSTRUCTION MEANS, METHODS, TECHNIQUES, SEQUENCES AND PROCEDURES AND FOR COORDINATING ALL PORTIONS OF THE WORK UNDER CONTRACT. UNLESS OTHERWISE NOTED.
- CONTRACTOR SHALL BE RESPONSIBLE FOR THE SAFETY OF THE WORK AREA, ADJACENT AREAS AND BUILDING OCCUPANTS THAT ARE LIKELY TO BE AFFECTED BY THE WORK UNDER THIS CONTRACT. WORK SHALL CONFORM TO ALL OSHA REQUIREMENTS.
- 10. CONTRACTOR SHALL COORDINATE HIS WORK WITH THE SUPERINTENDENT OF BUILDINGS & GROUNDS AND SCHEDULE HIS ACTIVITIES AND WORKING HOURS IN ACCORDANCE WITH THE REQUIREMENTS.
- 11. CONTRACTOR SHALL BE RESPONSIBLE FOR COORDINATING HIS WORK WITH THE WORK OF OTHERS AS IT MAY RELATE TO RADIO EQUIPMENT, ANTENNAS AND ANY OTHER PORTIONS OF THE WORK.
- 12. INSTALL ALL EQUIPMENT AND MATERIALS IN ACCORDANCE WITH MANUFACTURERS RECOMMENDATIONS UNLESS SPECIFICALLY OTHERWISE INDICATED OR WHERE LOCAL CODES OR REGULATIONS TAKE PRECEDENCE.
- 13. MAKE NECESSARY PROVISIONS TO PROTECT EXISTING SURFACES, EQUIPMENT, IMPROVEMENTS, PIPING ETC. AND IMMEDIATELY REPAIR ANY DAMAGE THAT OCCURS DURING CONSTRUCTION.
- 14. IN DRILLING HOLES INTO CONCRETE WHETHER FOR FASTENING OR ANCHORING PURPOSES, OR PENETRATIONS THROUGH THE FLOOR FOR CONDUIT RUNS, PIPE RUNS, ETC., MUST BE CLEARLY UNDERSTOOD THAT REINFORCING STEEL SHALL NOT BE DRILLED INTO, CUT OR DAMAGED UNDER ANY CIRCUMSTANCES (UNLESS NOTED OTHERWISE). LOCATIONS OF REINFORCING STEEL ARE NOT DEFINITELY KNOWN AND THEREFORE MUST BE SEARCHED FOR BY APPROPRIATE METHODS AND EQUIPMENT.
- 15. REPAIR ALL EXISTING WALL SURFACES DAMAGED DURING CONSTRUCTION SUCH THAT THEY MATCH AND BLEND IN WITH ADJACENT SURFACES.
- 16. SEAL PENETRATIONS THROUGH FIRE RATED AREAS WITH U.L. LISTED AND FIRE CODE APPROVED MATERIALS.
- 17. KEEP CONTRACT AREA CLEAN, HAZARD FREE, AND DISPOSE OF ALL DIRT, DEBRIS, AND RUBBISH. EQUIPMENT NOT SPECIFIED AS REMAINING ON THE PROPERTY OF THE OWNER SHALL BE REMOVED. LEAVE PREMISES IN CLEAN CONDITION AND FREE FROM PAINT SPOTS, DUST, OR SMUDGES OF ANY NATURE. CONTRACTOR SHALL BE RESPONSIBLE FOR MAINTAINING ALL ITEMS UNTIL COMPLETION OF CONSTRUCTION.
- 18. MINIMUM BEND RADIUS OF ANTENNA CABLES SHALL BE IN ACCORDANCE WITH CABLE MANUFACTURERS RECOMMENDATIONS.

- 19. ALL EXISTING INACTIVE SEWER, WATER, GAS, ELECTRIC AND OTHER UTILITIES, WHICH INTERFERE WITH THE EXECUTION OF THE WORK, SHALL BE REMOVED AND/OR CAPPED, PLUGGED OR OTHERWISE DISCONTINUED AT POINTS WHICH WILL NOT INTERFERE WITH THE EXECUTION OF THE WORK SUBJECT TO THE APPROVAL OF THE ENGINEER.
- 20. CONTRACTOR SHALL MINIMIZE DISTURBANCE TO EXISTING SITE DURING CONSTRUCTION. EROSION CONTROL MEASURES, IF REQUIRED DURING CONSTRUCTION SHALL BE IN CONFORMANCE WITH JURISDICTIONAL OR STATE AND LOCAL GUIDELINES FOR EROSTION AND SEDIMENT CONTROL AND COORDINATED WITH LOCAL REGULATORY AUTHORITIES.
- 21. LIGHT SHADED LINES AND NOTES REPRESENT WORK PREVIOUSLY DONE. DARK SHADED LINES AND NOTES REPRESENT THE SCOPE OF WORK FOR THIS PROJECT. CONTRACTOR SHALL VERIFY IF EXISTING CONSTRUCTION IS COMPLETE. CONTRACTOR SHALL NOTIFY ENGINEER OF ANY EXISTING CONDITIONS THAT DEVIATE FROM THE DRAWINGS PRIOR TO BEGINNING CONSTRUCTION
- 22. CONTRACTOR SHALL SECURE ALL NECESSARY PERMITS AND/OR WIRING CERTIFICATES REQUIRED FOR THE ELECTRICAL SERVICE UPGRADE. IN ADDITION, CONTRACTOR SHALL PROVIDE ALL NECESSARY COORDINATION AND SCHEDULING WITH THE SERVING ELECTRICAL UTILITY AND LOCAL INSPECTION AUTHORITIES.
- 23. PRIOR TO STARTING CONTRACTOR SHALL PROVIDE MTVE A COI LISTING MTVE AS CERTIFICATE HOLDER AND ADDITIONAL INSURED.
- 24. ALL SUPPORT STRUCTURES, ANTENNAS, ASSOCIATED HARDWARE, AND CABLES SHALL BE PAINTED PER MTVE SPEC.
- 25. KEEP ALL SITE EQUIPMENT OFF THE GRASS AND RESERVOIR RING PAD.
- 26. SANITATION FACILITIES ARE TO BE PROVIDED BY CONTRACTOR.
- 27. SCHEDULE AN ONSITE PRE-CON WITH MTVE 7 DAYS PRIOR TO START.
- 28. MAINTAIN A MINIMUM 4-INCH CLEARANCE BETWEEN RESERVOIR SHELL AND ALL EQUIPMENT. CABLES, ETC.
- 29. REMOVE ALL UNUSED EQUIPMENT, MOUNTS, CABLE, ETC.

ELECTRICAL NOTES

- 1. ELECTRICAL CONTRACTOR SHALL SUPPLY AND INSTALL ANY/ALL ELECTRICAL WORK INDICATED. ANY/ALL CONSTRUCTION SHALL BE IN ACCORDANCE WIDRAWINGS AND ANY/ALL APPLICABLE SPECIFICATIONS. IF ANY PROBLEMS ARE ENCOUNTERED BY COMPLYING WITH THESE REQUIREMENTS, CONTRACTOR SHALL NOTIFY 'CONSTRUCTION MANAGER' AS SOON AS POSSIBLE, AFTER THE DISCOVERY OF THE PROBLEMS, AND SHALL NOT PROCEED WITH THAT PORTION OF WORK, UNTIL THE 'CONSTRUCTION MANAGER' HAS DIRECTED THE CORRECTIVE ACTIONS TO BE TAKEN.
- ELECTRICAL CONTRACTOR SHALL VISIT THE JOB SITE AND FAMILIARIZE HIMSELF WITH ANY/ALL CONDITIONS AFFECTING ELECTRICAL AND COMMUNICATION INSTALLATION AND MAKE PROVISIONS AS TO THE COST THEREOF. ALL EXISTING CONDITIONS OF ELECTRICAL EQUIP., LIGHT FIXTURES, ETC., THAT ARE PART OF THE FINAL SYSTEM, SHALL BE VERIFIED BY THE CONTRACTOR, PRIOR TO THE SUBMITTAL OF HIS BID. FAILURE TO COMPLY WITH THIS PARAGRAPH WILL IN NO WAY RELIEVE CONTRACTOR OF PERFORMING ALL WORK NECESSARY FOR A COMPLETE AND WORKING SYSTEM.
- ALL WORK SHALL BE PERFORMED IN ACCORDANCE WITH THE LATEST EDITION OF THE NEC AND ALL CODES AND LOCAL ORDINANCES OF THE LOCAL POWER & TELEPHONE COMPANIES HAVING JURISDICTION AND SHALL INCLUDED BUT NOT BE LIMITED TO:
 - A. UL -- UNDERWRITERS LABORATORIES
 - B. NEC -- NATIONAL ELECTRICAL CODE
 - C. NEMA -- NATIONAL ELECTRICAL MANUFACTURERS ASSOC.
- D. OSHA -- OCCUPATIONAL SAFETY AND HEALTH ACT E. IBC -- INTERNATIONAL BUILDING CODE
- F. NFPA -- NATIONAL FIRE CODES
- T. MITA WITHOUTE TIME GODES
- DO NOT SCALE ELECTRICAL DRAWINGS, REFER TO SITE PLANS AND ELEVATIONS FOR EXACT LOCATIONS OF ALL EQUIPMENT, AND CONFIRM WITH 'CONSTRUCTION MANAGER' ANY SIZES AND AND LOCATIONS WHEN NEEDED.
- 5. EXISTING SERVICES: CONTRACTOR SHALL NOT INTERRUPT EXISTING SERVICES WITHOUT WRITTEN PERMISSION.
- CONTRACTOR SHALL PAY FOR ANY/ALL PERMITS, FEES, INSPECTIONS AND TESTING.
 CONTRACTOR IS TO OBTAIN PERMITS AND APPROVED SUBMITTALS PRIOR TO THE WORK
 BEGINNING OR ORDERING EQUIPMENT.
- THE TERM "PROVIDE" USED IN CONSTRUCTION DOCUMENTS AND SPECIFICATIONS, INDICATES THAT THE CONTRACTOR SHALL FURNISH AND INSTALL.
- 8. CONTRACTOR SHALL CONFIRM WITH LOCAL UTILITY COMPANY ANY/ALL REQUIREMENTS SUCH AS THE: LUG SIZE RESTRICTIONS, CONDUIT ENTRY, SIZE OF TRANSFORMERS, SCHEDULED DOWNTIME FOR THE OWNERS' CONFIRMATION, ETC. ANY/ALL CONFLICTS SHALL BE BROUGHT TO THE ATTENTION OF THE CONSTRUCTION MANAGER, PRIOR TO BEGINNING ANY WORK.
- MINIMUM WIRE SIZE SHALL BE #12 AWG, NOT INCLUDING CONTROL WIRING, UNLESS NOTED OTHERWISE. ALL CONDUCTORS SHALL BE COPPER WITH THWN INSULATION.
- 10. OUTLET BOXES SHALL BE PRESSED STEEL IN DRY LOCATIONS, CAST ALLOY WITH THREADED HUBS IN WET/DAMP LOCATIONS AND SPECIAL ENCLOSURES FOR OTHER CLASSIFIED AREAS.

- 11. IT IS NOT THE INTENT OF THESE PLANS TO SHOW EVERY MINOR DETAIL OF THE CONSTRUCTION. CONTRACTOR IS EXPECTED TO FURNISH AND INSTALL ALL ITEMS FOR A COMPLETE ELECTRICAL SYSTEM AND PROVIDE ALL REQUIREMENTS FOR THE EQUIPMENT TO BE PLACED IN PROPER WORKING ORDER.
- 12. ELECTRICAL SYSTEM SHALL BE AS COMPLETELY AND EFFECTIVELY GROUNDED, AS REQUIRED BY SPECIFICATION, SET FORTH BY SPRINT.
- 13. ALL WORK SHALL BE PERFORMED BY A LICENSED ELECTRICAL CONTRACTOR IN A FIRST CLASS, WORKMANLIKE MANNER. THE COMPLETED SYSTEM SHALL BE FULL OPERATIVE AND SUBJECT TO REGULATORY INSPECTION AND APPROVAL BY CONSTRUCTION MANAGER
- 14. ALL WORK SHALL BE COORDINATED WITH OTHER TRADES TO AVOID INTERFERENCE WITH THE PROGRESS OF CONSTRUCTION.
- 15. CONTRACTOR SHALL GUARANTEE ANY/ALL MATERIALS AND WORK FREE FROM DEFECTS OR A PERIOD OF NOT LESS THAN TWO YEARS FROM DATE OF CUSTOMER'S ACCEPTANCE.
- 16. THE CORRECTION OF ANY DEFECTS SHALL BE COMPLETED WITHOUT ANY ADDITIONAL CHARGE AND SHALL INCLUDE THE REPLACEMENT OF THE REPAIR OF ANY OTHER PHASE OF THE INSTALLATION WHICH MAY HAVE REFN DAMAGED THEREIN WITHIN 48 HOURS
- 17. ADEQUATE AND REQUIRED LIABILITY INSURANCE SHALL BE PROVIDED FOR PROTECTION AGAINST PUBLIC LOSS AND ANY/ALL PROPERTY DAMAGE FOR THE DURATION OF WORK.
- 18. PROVIDE AND INSTALL CONDUIT, CONDUCTORS, PULL WIRES, BOXES, COVER PLATES AND DEVICES FOR ALL OUTLETS AS INDICATED.
- DITCHING AND BACK FILL (WHEN APPLICABLE): CONTRACTOR SHALL PROVIDE FOR ALL UNDERGROUND INSTALLED CONDUIT AND/OR CABLES INCLUDING EXCAVATION AND BACKFILLING AND COMPACTION. REFER TO NOTES AND REQUIREMENTS, EXCAVATION, AND BACKFILLING
- 20. MATERIALS, PRODUCTS AND EQUIPMENT, INCLUDING ALL COMPONENTS THEREOF, SHALL BE NEW AND SHALL APPEAR ON THE LIST OF U.L. APPROVED ITEMS AND SHALL MEET OR EXCEED THE REQUIREMENTS OF THE NEC, NEMA AND IEEE.
- 21. CONTRACTOR SHALL SUBMIT SHOP DRAWINGS OR MANUFACTURES CATALOG INFORMATION OF ANY/ALL LIGHTING FIXTURES, SWITCHES AND ALL OTHER ELECTRICAL ITEMS FOR APPROVAL BY THE CONSTRUCTION MANAGER PRIOR TO INSTALLATION.
- 22. ANY CUTTING OR PATCHING DEEMED NECESSARY FOR ELECTRICAL WORK IS THE ELECTRICAL CONTRACTORS RESPONSIBILITY AND SHALL BE INCLUDED IN THE COST FOR WORK AND PERFORMED TO THE SATISFACTION OF THE 'CONSTRUCTION MANAGER' UPON FINAL ACCEPTANCE.
- 23. THE ELECTRICAL CONTRACTOR SHALL LABEL ALL PANELS WITH ONLY TYPEWRITTEN DIRECTORIES. ALL ELECTRICAL WIRING SHALL BE THE RESPONSIBILITY OF THE ELECTRICAL CONTRACTOR.
- 24. DISCONNECT SWITCHES SHALL BE H.P. RATED HEAVY-DUTY, QUICK-MAKE AND QUICK-BREAK ENCLOSURES, AS REQUIRED BY EXPOSURE TYPE.
- 25. ALL CONNECTIONS SHALL BE MADE WITH A PROTECTIVE COATING OF AN ANTI-OXIDE COMPOUND SUCH AS "NO-OXIDE A" BY DEARBORNE CHEMICAL CO. COAT ALL WIRE SURFACES BEFORE CONNECTING. EXPOSED COPPER SURFACES, INCLUDING GROUND BARS. SHALL BE TREATED - NO SUBSTITUTIONS.
- 26. RACEWAYS: CONDUIT SHALL BE SCHEDULE 40 PVC MEETING OR EXCEEDING NEMA TC2 1990. CONTRACTOR SHALL PLUG AND CAP EACH END OF SPARE AND EMPTY CONDUITS AND PROVIDE TWO SEPARATE PULL STRINGS 200 LBS TEST POLYETHYLENE CORD. ALL CONDUIT BENDS SHALL BE A MINIMUM OF 2 FT. RADIUS. RGS CONDUITS WHEN SPECIFIED, SHALL MEET UL-6 FOR GALVANIZED STEEL. ALL FITTINGS SHALL BE SUITABLE FOR USE WITH THREADED RIGID CONDUIT. COAT ALL THREADS WITH 'BRITE ZINC' OR 'GOLD CALV'.
- 27. SUPPORT OF ALL ELECTRICAL WORK SHALL BE AS REQUIRED BY NEC.
- 28. CONDUCTORS: CONTRACTOR SHALL USE 98% CONDUCTIVITY COPPER WITH TYPE THWN INSULATION, 600 VOLT, COLOR CODED. USE SOLID CONDUCTORS FOR WIRE UP TO AND INCLUDING NO. 8 AWG. USE STRANDED CONDUCTORS FOR WIRE ABOVE NO. 8 AWG.
- 29. CONNECTORS FOR POWER CONDUCTORS: CONTRACTOR SHALL USE PRESSURE TYPE INSULATED TWIST-ON CONNECTORS FOR NO. 10 AWG AND SMALLER. USE SOLDERLESS MECHANICAL TERMINAL LUGS FOR NO. 8 AWG AND LARGER.
- SERVICE: 240/120V, SINGLE PHASE, 3 WIRE CONNECTIONS AVAILABLE FROM UTILITY COMPANY. OWNER OR OWNERS AGENT WILL APPLY FOR POWER.
- 31. TELEPHONE SERVICE: CONTRACTOR SHALL PROVIDE EMPTY CONDUITS WITH MULE TAPE AS INDICATED ON DRAWINGS.
- 32. ELECTRICAL AND TELCO RACEWAYS TO BE BURIED A MINIMUM OF 2' DEPTH.
- 33. CONTRACTOR SHALL PLACE TWO LENGTHS OF WARNING TAPE AT A DEPTH OF 12" BELOW GROUND AND DIRECTLY ABOVE ELECTRICAL AND TELCO SERVICE CONDUITS. CAUTIONS TAPE TO READ "CAUTION BURIED ELECTRIC" OR "BURIED TELECOM".
- 34. ALL BOLTS SHALL BE STAINLESS STEEL.



SAN RAMON, CA 94583

PLANS PREPARED BY:



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> 1635 KELLOGG AVENUE CORONA, CA 91718

SHEET TITLE:

I GENERAL NOTES

SHEET NUMBER:

N-1

(CONTINUED FROM N-1)

ANTENNA & COAX NOTES

- 1. VERIFY EACH COAXIAL CABLE CABLE LENGTH, DIAMETER, ROUTING, COLOR CODING AND ALL APPURTENANCES.
- 2. THE MAXIMUM COAXIAL CABLE LENGTH AND CORRESPONDING COAXIAL CABLE DIAMETER IS SHOWN ON DRAWINGS. THIS CABLE LENGTH IS TO BE USED FOR FABRICATION OR CONSTRUCTION. ACTUAL ANTENNA CABLE LENGTH(S) MUST BE
- 3. ALL COAX CABLES SHALL UTILIZE GROUND KITS, GROUNDED AS FOLLOWS:
 - NEAR ANTENNA RAD CENTER ELEVATION,
 - MIDDLE OF TOWER (MID-HEIGH OF ANTENNA), IF CABLE RUN IS OVER 200',
 - BOTTOM OF TOWER,
 - AT MASTER GROUND BAR 3'-0" FROM MMBS-BBU CABINET
- 4. ALL TOP JUMPERS SHALL BE LENGTHS AS SHOWN AND INSTALLED BY
- 5. ALL CABLES SHALL BE COLOR CODED AND IN ACCORDANCE WITH SPRINT SPECIFICATIONS.
- 6. BANDING SHALL BE AS FOLLOWS:
 - MAIN LINE COLOR BANDS SHALL BE 2" WIDE. MAINTAIN 1" SPACING BETWEEN COLORS.
 - FREQUENCY COLOR BANDS SHALL BE 2" WIDE WITH NO SPACE BETWEEN
 - JUMPER COLOR BANDS SHALL BE 1" WIDE WITH 1" SPACE. START COLOR BANDS 2" BEYOND WEATHERPROOFING.

 - START SELECTOR COLOR NEXT TO END CONNECTORS.
- 7. FINAL COAXIAL ANTENNA CABLE SIZES SHALL BE DETERMINED BY RF ENGINEER. SEE ANTENNA SCHEDULE SHEET A-4. BASED ON FINAL CABLE RUN LENGTHS DETERMINED.
- 8. SEE CONSTRUCTION MANAGER FOR ANTENNA SUPPORT ASSEMBLY TYPE.
- 9. ALL COAXIAL CABLE WILL BE SECURED TO THE DESIGNED SUPPORT STRUCTURE AT DISTANCES NOT TO EXCEED 3' OR THE CABLE MANUFACTURES SPECIFICATIONS WHICHEVER IS LESS, WITH HARDWARE SPECIFIED IN THE COAXIAL CABLE ROUTING DETAILS OF THE SUPPLIED STRUCTURAL REPORT.
- 10. PROVIDE AT LEAST 6" OF SLACK IN THE MAIN COAXIAL CABLES AT THE ANTENNA MOUNTING ELEVATION TO PROVIDE FOR FUTURE CONNECTOR REPLACEMENT.

ANTENNA & HYBRID CABLE NOTES

- 1. VERIFY EACH HYBRID CABLE LENGTH, ROUTING, DIAMETER, COLOR CODING
- 2. THE HYBRID CABLE AND DIAMETER LENGTH IS SHOWN ON A-4. EXCESS CABLE LENGTHS TO BE DRESSED IN A MANNER APPROVED. CABLES CANNOT BE CUT
- 3. HYBRID CABLE INTERNAL GROUND WIRE TO BE GROUNDED AT TOP AND BOTTOM PER SAMSUNG'S (SPRINT) SPECIFICATIONS.
- 4. EXCESS TOP 15' HYBRID CABLE FIBER JUMPERS TO BE DRESSED IN A MANNER APPROVED, CANNOT BE COILED, MUST BE SECURED TO TOWER MOUNTS..
- 5. ALL MAIN CABLES SHALL BE COLOR CODED AS SHOWN ON SHEET RF-1 & IN ACCORDANCE WITH SPRINT SPECIFICATIONS.
- 6. BANDING SHALL BE IN ACCORDANCE WITH SHEET A-4, RF-1. MAIN LINE COLOR BANDS SHALL BE 2" WIDE. MAINTAIN 1" SPACING
 - JUMPER COLOR BANDS SHALL BE 1" WIDE WITH 1" SPACE.
 - START COLOR BANDS 2" BEFORE MAIN CABLE END.
- 7. FINAL HYBRID CABLE SIZES SHALL BE DETERMINED BY SAMSUNG RF ENGINEER. SEE HYBRID CABLE SCHEDULE SHEET RF-1, BASED ON FINAL CABLE RUN LENGTHS DETERMINED.
- 8. ALL HYBRID CABLE WILL BE SECURED TO THE DESIGNED SUPPORT STRUCTURE AT DISTANCES NOT TO EXCEED 3' HORIZONTALLY OR 4' VERTICALLY OR THE CABLE MANUFACTURER'S SPECIFICATIONS WHICHEVER IS LESS, WITH HARDWARE SPECIFIED IN THE HYBRID CABLE ROUTING DETAILS OF THE SUPPLIED STRUCTURAL SUPPORT.



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SHEET TITLE:

GENERAL NOTES

THESE OUTLINE SPECIFICATIONS IN CONJUNCTION WITH THE SPRINT STANDARD CONSTRUCTION SPECIFICATIONS, INCLUDING CONTRACT DOCUMENTS AND THE CONSTRUCTION DRAWINGS DESCRIBE THE WORK TO BE PERFORMED BY THE CONTRACTOR

SECTION 01 100 - SCOPE OF WORK

THE WORK

SHALL COMPLY WITH ALL APPLICABLE ADOPTED CODES AND STANDARDS, AND PORTIONS THEREOF, SPRINT METHOD OF PROCEDURE (MOP) AND SPRINT STANDARDS AT THE TIME OF CONSTRUCTION START.

PRECEDENCE

SHOULD CONFLICTS OCCUR BETWEEN THE STANDARD CONSTRUCTION SPECIFICATIONS FOR WIRELESS SITES INCLUDING THE STANDARD CONSTRUCTION DETAILS FOR WIRELESS SITES AND THE CONSTRUCTION DRAWINGS, INFORMATION ON THE CONSTRUCTION DRAWINGS SHALL TAKE PRECEDENCE, ALONG WITH SPRINT CONSTRUCTION MANAGER APPROVAL.

TE EAMILIADITY:

CONTRACTOR SHALL BE RESPONSIBLE FOR FAMILIARIZING HIMSELF WITH ALL CONTRACT DOCUMENTS, FIELD CONDITIONS AND DIMENSIONS PRIOR TO PROCEEDING WITH CONSTRUCTION.

ON-SITE SUPERVISION:

THE CONTRACTOR SHALL SUPERVISE AND DIRECT THE WORK AND SHALL BE RESPONSIBLE FOR CONSTRUCTION MEANS, METHODS, TECHNIQUES, SEQUENCES, AND PROCEDURES IN ACCORDANCE WITH THE CONTRACT DOCUMENTS.

DRAWINGS, SPECIFICATIONS AND DETAILS REQUIRED AT JOBSITE

THE CONSTRUCTION CONTRACTOR SHALL MAINTAIN A FULL SET OF THE CONSTRUCTION DRAWINGS AT THE JOBSITE FROM MOBILIZATION THROUGH CONSTRUCTION COMPLETION.

- A. DETAILS ARE INTENDED TO SHOW DESIGN INTENT. PROVIDE ALL MATERIALS AND LABOR AS REQUIRED TO PROVIDE A COMPLETE AND FUNCTIONING SYSTEM. MODIFICATIONS MAY BE REQUIRED TO SUIT JOB DIMENSIONS OR CONDITIONS, AND SUCH MODIFICATIONS SHALL BE INCLUDED AS PART OF THE WORK.
- B. CONTRACTOR SHALL NOTIFY SPRINT CONSTRUCTION MANAGER OF ANY VARIATIONS PRIOR TO PROCEEDING WITH THE WORK DIMENSIONS SHOWN ARE TO FINISH SURFACES UNLESS NOTED OTHERWISE. MODIFICATIONS MAY BE REQUIRED TO SUIT JOB DIMENSIONS OR CONDITIONS, AND SUCH MODIFICATIONS SHALL BE INCLUDED AS PART OF THE WORK.
- C. MARK THE FIELD SET OF DRAWINGS IN RED, DOCUMENTING ANY CHANGES FROM THE CONSTRUCTION DOCUMENTS.

METHODS OF PROCEDURE (MOPS) FOR CONSTRUCTION:

CONTRACTOR SHALL PERFORM WORK AS DESCRIBED IN THE FOLLOWING INSTALLATION AND COMMISSIONING MOPS. CONTRACTOR IS RESPONSIBLE FOR DISTRIBUTION OF LATEST MOPS.

- A. TOP HAT
- B. HOW TO INSTALL A NEW CABINET
- C. BASE BAND UNIT IN EXISTING UNIT
- D. INSTALLATION OF BATTERIES
- E. INSTALLATION OF FIBER CABLE
- F. INSTALLATION OF RRU'S
- G. CABLING
- H. TS-0200 REV 5 ANTENNA LINE ACCEPTANCE STANDARDS
- I. SPRINT CELL SITE ENGINEERING NOTICE EN 2012-001, REV 1.
- J. COMMISSIONING MOPS

SECTION 01 200 - COMPANY FURNISHED MATERIAL AND EQUIPMENT

- A. COMPANY FURNISHED MATERIAL AND EQUIPMENT IS IDENTIFIED ON THE RF DATA SHEET IN THE CONSTRUCTION DRAWINGS.
- B. CONTRACTOR IS RESPONSIBLE FOR SPRINT PROVIDED MATERIAL AND EQUIPMENT TO ENSURE IT IS PROTECTED AND HANDLED PROPERLY THROUGHOUT THE CONSTRUCTION DURATION.
- C. CONTRACTOR RESPONSIBLE FOR RECEIPT OF SPRINT FURNISHED EQUIPMENT AT CELL SITE OR CONTRACTORS LOCATION. CONTRACTOR TO COMPLETE SHIPPING AND RECEIPT DOCUMENTATION IN ACCORDANCE WITH COMPANY PRACTICE. CONTRACTOR MAY BE REQUIRED TO PICK UP MATERIAL AT LOCATION PRESCRIBED BY SPRINT.

SECTION 01 300 - CELL SITE CONSTRUCTION

NOTICE TO PROCEED

NO WORK SHALL COMMENCE PRIOR TO COMPANY'S WRITTEN NOTICE TO PROCEED AND THE ISSUANCE OF WORK ORDER.

SITE CLEANLINESS

CONTRACTOR SHALL KEEP THE SITE FREE FROM ACCUMULATING WASTE MATERIAL, DEBRIS AND TRASH. AT THE COMPLETION OF THE WORK, CONTRACTOR SHALL REMOVE FROM THE SITE ALL REMAINING RUBBISH, IMPLEMENTS, TEMPORARY FACILITIES, AND SURPLUS MATERIALS.

SECTION 01 400 - SUBMITTALS & TESTS

ALTERNATES:

AT THE COMPANY'S REQUEST, ANY ALTERNATIVES TO THE MATERIALS OR METHODS SPECIFIED SHALL BE SUBMITTED TO SPRINTS CONSTRUCTION MANAGER FOR APPROVAL. SPRINT WILL REVIEW AND APPROVE ONLY THOSE REQUESTS MADE IN WRITING. NO VERBAL APPROVALS WILL BE CONSIDERED.

TESTS AND INSPECTIONS:

- A. THE CONTRACTOR SHALL BE RESPONSIBLE FOR ALL CONSTRUCTION TESTS, INSPECTIONS AND PROJECT DOCUMENTATION.
- B. CONTRACTOR SHALL ACCOMPLISH TESTING INCLUDING BUT NOT LIMITED TO THE
- COAX SWEEPS AND FIBER TESTS PER TS-0200 REV 4 ANTENNA LINE ACCEPTANCE STANDARDS
- AGL, AZIMUTH AND DOWNTILT PROVIDE AN AUTOMATED REPORT UPLOADED TO SITERRA USING A COMMERCIAL MADE-FOR THE PURPOSE ELECTRONIC ANTENNA ALIGNMENT TOOL (AAT). INSTALLED AZIMUTH, CENTERLINE AND DOWNTILT MUST CONFORM WITH RF CONFIGURATION DATA.
- 3. CONTRACTOR SHALL BE RESPONSIBLE FOR ANY AND ALL CORRECTIONS TO ANY WORK IDENTIFIED AS UNACCEPTABLE IN SITE INSPECTION ACTIVITIES AND/OR AS A RESULT OF TESTING
- 4. ALL TESTING REQUIRED BY APPLICABLE INSTALLATION MOPS.
- C. REQUIRED CLOSEOUT DOCUMENTATION INCLUDES, BUT IS NOT LIMITED TO THE FOLLOWING;
- 1. AZIMUTH, DOWNTILT, AGL FROM SUNSIGHT INSTRUMENTS ANTENNALIGN ALIGNMENT TOOL (AAT)
- 2. SWEEP AND FIBER TESTS
- SCALABLE BARCODE PHOTOGRAPHS OF TOWER TOP AND INACCESSIBLE SERIALIZED EQUIPMENT
- 4. ALL AVAILABLE JURISDICTIONAL PERMIT AND OCCUPANCY INFORMATION
- 5. PDF SCAN OF REDLINES PRODUCED IN FIELD
- A PDF SCAN OF REDLINE MARK-UPS SUITABLE FOR USE IN ELECTRONIC AS-BUILT DRAWING PRODUCTION
- 7. LIEN WAIVERS
- 8. FINAL PAYMENT APPLICATION
- 9. REQUIRED FINAL CONSTRUCTION PHOTOS
- 10. CONSTRUCTION AND COMMISSIONING CHECKLIST COMPLETE WITH NO DEFICIENT ITEMS
- 11. APPLICABLE POST NTP TASKS INCLUDING DOCUMENT UPLOADS COMPLETED IN SITERRA (SPRINTS DOCUMENT REPOSITORY OF RECORD).
- 12. CLOSEOUT PHOTOGRAPHS AND CLOSEOUT CHECKLIST: SPRINT WILL PROVIDE SEPARATE GUIDANCE.
 - a. PROVIDE PHOTOGRAPHS OF FINAL PROJECT PER THE FOLLOWING LIST. ADDITIONAL PHOTOS MAY BE REQUIRED TO SUPPORT ACCEPTANCE PROCESSES.
 - (1) BACK MAIN FIBER CABLE ROUTE (MINIMUM TWO PHOTOS)
 - (2) OF EACH ANTENNA AND RRU
 - $\hbox{(3)} \quad \hbox{MANUFACTURERS NAME TAG FOR ALL SERIALIZED EQUIPMENT}$
 - 4) PULL AND DISTRIBUTION BOXES INTERMEDIATE BETWEEN RRU'S AND RBS (DOOR OPEN)
 - RBS CABINET WITH DOOR OPEN SHOWING MODIFICATIONS
 - (6) POWER CABINET, DOORS OPEN, BATTERIES INSTALLED
 - (7) BREAK OUT CYLINDERS
 - (8) ASR SIGNAGE FOR SPRINT OWNED TOWERS
 - (9) RADIATION EXPOSURE WARNING SIGNS
 - (10) PHOTOGRAPH FROM EACH SECTOR FROM APPROXIMATELY RAD CENTER OF ANY NEW ANTENNA AT HORIZON.
 - b. LOAD PHOTOS TO SITERRA PROJECT LIBRARY 15. IN 15 CREATE NEW CATEGORY; 2.5 DEPLOYMENT, AND SECTION; PERMANENT CONSTRUCTION, LABEL PHOTOS WITH SITE CASCADE AND VIEW BEING DEPICTED. CAMERAS USED TO TAKE PHOTOS SHALL BE GPS ENABLED SUCH THAT THE GPS COORDINATES ARE INCLUDED IN THE PHOTO MEDIA-FILE INFORMATION.

COMMISSIONING:

PERFORM ALL COMMISSIONING AS REQUIRED BY APPLICABLE MOPS.

INTEGRATION:

PERFORM ALL INTEGRATION ACTIVITIES AS REQUIRED BY APPLICABLE MOPS.

SECTION 09 900 - PAINTING

QUALITY ASSURANCE:

- A. COMPLY WITH GOVERNING CODES AND REGULATIONS. PROVIDE PRODUCTS OF ACCEPTABLE MANUFACTURERS WHICH HAVE BEEN IN SATISFACTORY USE IN SIMILIAR SERVICE FOR THREE YEARS. USE EXPERIENCED INSTALLERS. DELIVER, HANDLE AND STORE MATERIALS IN ACCORDANCE WITH MANUFACTURER'S INSTRUCTIONS.
- B. COMPLY WITH ALL ENVIRONMENTAL REGULATIONS FOR VOLATILE ORGANIC COMPOUNDS.

MATERIALS (MTVE SPEC):

 A. MANUFACTURERS: TNEMEC. PROVIDE PREMIUM GRADE, PROFESSIONAL-QUALITY PRODUCTS FOR COATING SYSTEMS.

RESERVOIR AND EQUIPMENT PAINTING (MTVE SPEC):

- A. DO NOT PROCEED UNLESS TEMPERATURE, HUMIDITY, AND ALL OTHER CONDITIONS ARE PER TNEMEC APPLICATION INSTRUCTIONS.
- SSPC-SP11 POWER-TOOL CLEANING TO BARE METAL SURFACE PREP ALL NEW AND DISTURBED AREAS TO INCLUDE A 1 MIL PROFILE, USE A 30 GRIT POWER WHEEL. REMOVE ALL GRINDING RESIDUE FROM THE ENTIRE RESERVOIR SHELL AND ALL OTHER AREAS IMMEDIATELY.
- C. PRIMER ALL NEW MATERIALS AND DISTURBED SURFACES WITH TNEMEC SERIES 27, APPLY 4-6 MILS WITH A ROLLER.
- D. TWO FINISH COATS OF TNEMEC SERIES 1029, 2-4 MILS EACH WITH A ROLLER. OBSERVE PROPER DRY TIME BETWEEN COATS. COLOR IS 15BL TANK WHITE.

PAINTING APPLICATION:

- A. INSPECT SURFACES, REPORT UNSATISFACTORY CONDITIONS IN WRITING; BEGINNING WORK MEANS ACCEPTANCE OF SUBSTRATE.
- B. COMPLY WITH MANUFACTURER'S INSTRUCTIONS AND RECOMMENDATIONS FOR PREPARATION, PRIMING AND COATING WORK. COORDINATE WITH WORK OF OTHER SECTIONS.
- C. MATCH APPROVED MOCK-UPS FOR COLOR, TEXTURE, AND PATTERN. RE-COAT OR REMOVE AND REPLACE WORK WHICH DOES NOT MATCH OR SHOWS LOSS OF ADHESION.
- D. CLEAN UP, TOUCH UP AND PROTECT WORK.

SECTION 11 700 - ANTENNA ASSEMBLY, REMOTE RADIO UNITS AND CABLE INSTALLATION

SUMMARY:

THIS SECTION SPECIFIES INSTALLATION OF ANTENNAS, RRU'S, AND CABLE EQUIPMENT, INSTALLATION, AND TESTING OF COAXIAL FIBER CABLE.

ANTENNAS AND RRU'S:

THE NUMBER AND TYPE OF ANTENNAS AND RRU'S TO BE INSTALLED IS DETAILED ON THE CONSTRUCTION DRAWINGS.

HYBRID CABLE:

HYBRID CABLE WILL BE DC/FIBER AND FURNISHED FOR INSTALLATION AT EACH SITE. CABLE SHALL BE INSTALLED PER THE CONSTRUCTION DRAWINGS AND THE APPLICABLE MANUFACTURER'S REQUIREMENTS.

JUMPERS AND CONNECTORS:

FURNISH AND INSTALL 1/2" COAX JUMPER CABLES BETWEEN THE RRU'S AND ANTENNAS. JUMPERS SHALL BE TYPE LDF 4, FLC 12-50, CR 540, OR FXL 540. SUPER-FLEX CABLES ARE NOT ACCEPTABLE. JUMPERS BETWEEN THE RRU'S AND ANTENNAS OR TOWER TOP AMPLIFIERS SHALL CONSIST OF 1/2 INCH FOAM DIELECTRIC, OUTDOOR RATED COAXIAL CABLE, MIN LENGTH FOR JUMPER SHALL BE SO AS TO ALLOW FOR THE PROPER BEND RADIUS PER MANUFACTURER OR SPRINT SPECIFICATIONS.



SAN RAMON, CA 94583

PLANS PREPARED BY:



Md7, LLC 10590 West Ocean Air Dr. Suite 300 San Diego, CA 92130 858-964-7439

Md7 PROJECT NUMBER:

DRAWN BY:		CHECKED BY:
JC		AF
REV.	DATE:	ISSUED FOR:
A	07/31/2018	90% ZD FOR REVIEW
0	08/17/2018	100% ZD
-		
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 All drawings and written material contained herein may not be duplicated, used or disclose without the written consent of the architect.

SITE INFORMATION SITE NAME:

KELLOG PARK

SITE CASCADE: RV77XC011

SITE ADDRESS: 1635 KELLOGG AVENUE CORONA, CA 91718

CORONA, CA

SPRINT SPECIFICATIONS

SHEET NUMBER:

SP-1

(CONTINUED FROM SP-1)

REMOTE ELECTRICAL TILT (RET) CABLES:

FURNISH INSTALL RET CABLE AND CONNECTORS BETWEEN RRU AND ANTENNAS. CABLE SHALL BE AS REQUIRED BY MANUFACTURER.

MISCELLANEOUS:

INSTALL SPLITTERS, COMBINERS, FILTERS PER RF DATA SHEET, FURNISHED BY SPRINT.

ANTENNA INSTALLATION

THE CONTRACTOR SHALL ASSEMBLE ALL ANTENNAS ONSITE IN ACCORDANCE WITH THE INSTRUCTIONS SUPPLIED BY THE MANUFACTURER. ANTENNA HEIGHT, AZIMUTH, AND FEED ORIENTATION INFORMATION SHALL BE A DESIGNATED ON THE CONSTRUCTION DRAWINGS.

- A. THE CONTRACTOR SHALL POSITION THE ANTENNA ON TOWER PIPE MOUNTS SO THAT THE BOTTOM STRUT IS LEVEL. THE PIPE MOUNTS SHALL BE PLUMB TO WITHIN
- 1 DEGREE
- B. ANTENNA MOUNTING REQUIREMENTS: PROVIDE ANTENNA MOUNTING HARDWARE AS INDICATED ON THE DRAWINGS.

HYBRID CABLE INSTALLATION:

- A. THE CONTRACTOR SHALL ROUTE, TEST, AND INSTALL ALL CABLES AS INDICATED ON THE CONSTRUCTION DRAWINGS AND IN ACCORDANCE WITH THE MANUFACTURER'S RECOMMENDATIONS.
- B. THE INSTALLED RADIUS OF THE CABLES SHALL NOT BE LESS THAN THE MANUFACTURER'S SPECIFICATIONS FOR BENDING RADII.
- C. EXTREME CARE SHALL BE TAKEN TO AVOID DAMAGE TO THE CABLES DURING HANDLING AND INSTALLATION.
 - 1. FASTENING MAIN HYBRID CABLES:
 - a. MONOPOLES: ALL CABLES SHALL BE INSTALLED INSIDE MONOPOLE (WHEN APPLICABLE) WITH CABLE SUPPORT GRIPS AS REQUIRED BY THE MANUFACTURER.
 - b. LATTICE AND GUYED TOWERS: ALL CABLES SHALL BE PERMANENTLY FASTENED TO THE COAX LADDER AT 4'-0" O.C. USING NON-MAGNETIC STAINLESS STEEL CLIPS. HOISTING GRIPS SHOULD BE INSTALLED AT MID-POINT AND TOP-SIDE IF CABLE RUN EXCEEDS 200'.
- FASTENING INDIVIDUAL FIBER AND DC CABLES ABOVE BREAKOUT ENCLOSURE (MEDUSA), WITHIN THE MMBS CABINET AND ANY INTERMEDIATE DISTRIBUTION BOXES:
 - a. FIBER: SUPPORT FIBER BUNDLES USING 1/2" VELCRO STRAPS OF THE REQUIRED LENGTH @ 18" OC. STRAPS SHALL BE UV, OIL AND WATER RESISTANT AND SUITABLE FOR INDUSTRIAL INSTALLATIONS AS MANUFACTURED BY TEXTOL OR APPROVED EQUAL.
 - b. DC: SUPPORT DC BUNDLES WITH ZIP TIES OF THE ADEQUATE LENGTH. ZIP TIES TO BE UV STABILIZED, BLACK NYLON, WITH TENSILE STRENGTH AT 12,000 PSI AS MANUFACTURED BY NELCO PRODUCTS OR EQUAL.
- 3. FASTENING OR SECURING JUMPERS: SECURE JUMPERS TO THE SIDE ARMS OR HEAD FRAMES USING STAINLESS STEEL TIE WRAPS OR STAINLESS STEEL CLIPS, 18" FROM REAR OF CONNECTOR AND 24" THEREAFTER, AT NO TIME SHALL THEY CONTACT TOWER OF STRUCTURAL STEEL.
- 4. CABLE INSTALLATION:
 - a. INSPECT CABLE PRIOR TO USE FOR SHIPPING DAMAGE, NOTIFY THE CONSTRUCTION MANAGER.
 - b. CABLE ROUTING: CABLE INSTALLATION SHALL BE PLANNED TO ENSURE THAT THE LINES WILL BE PROPERLY ROUTED IN THE CABLE ENVELOP AS INDICATED ON THE DRAWINGS. AVOID TWISTING AND CROSSOVERS.
 - c. HOIST CABLE USING PROPER HOISTING GRIPS. DO NOT EXCEED MANUFACTURES RECOMMENDED MAXIMUM BEND RADIUS.
- GROUNDING OF TRANSMISSION LINES: ALL TRANSMISSION LINES SHALL BE GROUNDED AS INDICATED ON DRAWINGS.
- HYBRID CABLE COLOR CODING: ALL COLOR CODING SHALL BE AS REQUIRED IN TS 0200 REV 5.
- HYBRID CABLE LABELING: INDIVIDUAL HYBRID AND DC BUNDLES SHALL BE LABELED ALPHA-NUMERICALLY ACCORDING TO SPRINT CELL SITE ENGINEERING NOTICE - EN 2012-001. REV 1

WEATHERPROOFING EXTERIOR CONNECTORS AND HYBRID CABLE GROUND KITS:

- A. ALL FIBER & COAX CONNECTORS AND GROUND KITS SHALL BE WEATHERPROOFED.
- B. WEATHERPROOFED USING ONE OF THE FOLLOWING METHODS. ALL INSTALLATIONS MUST BE DONE IN ACCORDANCE WITH THE MANUFACTURER'S RECOMMENDATIONS AND INDUSTRY BEST PRACTICES.
 - SELF-AMALGAMATING TAPE: CLEAN SURFACES. APPLY A DOUBLE WRAP OF SELF-AMALGAMATING TAPE 2" BEYOND CONNECTOR. APPLY A SECOND WRAP OF SELF-AMALGAMATING TAPE IN OPPOSITE DIRECTION. APPLY DOUBLE WRAP OF 2" WIDE ELECTRICAL TAPE EXTENDING 2" BEYOND THE SELF-AMALGAMATING TAPE.
 - 2. 3M SLIM LOCK CLOSURE 716: SUBSTITUTIONS WILL NOT BE ALLOWED.
- 3. JMA-WPS SERIES ENCLOSURE.
- 4. BUTYL AND TAPE, 1 COMPLETE WRAP OF 3/4" PRE-TAPE, BUTYL WRAPPED IN HALF INCH LAP LAYERS, ENDED WITH SHINGLED DOWNWARD 3 WRAPS OF 2" TAPE, 3 WRAPS OF 3/4" TAPE SHINGLED DOWNWARD, FREE OF WRINKLES, BUCKLES AND FLAGGING.
- 5. OPEN FLAME ON JOB SITE IS NOT ACCEPTABLE

$\frac{\text{SECTION 11 800 - INSTALLATION OF MULTIMODAL BASE STATIONS (MMBS) AND RELATED}{\text{EQUIPMENT}}$

SUMMARY:

- A. THIS SECTION SPECIFIES MMBS CABINETS, POWER CABINETS, AND INTERNAL EQUIPMENT INCLUDING BY NOT LIMITED TO RECTIFIERS, POWER DISTRIBUTION UNITS, BASE BAND UNITS, SURGE ARRESTORS, BATTERIES, AND SIMILAR EQUIPMENT FURNISHED BY THE COMPANY FOR INSTALLATION BY THE CONTRACTOR (OFCI).
- B. CONTRACTOR SHALL PROVIDE AND INSTALL ALL MISCELLANEOUS MATERIALS AND PROVIDE ALL LABOR REQUIRED FOR INSTALLATION EQUIPMENT IN EXISTING CABINET OR NEW CABINET AS SHOWN ON DRAWINGS AND AS REQUIRE BY THE APPLICABLE INSTALLATION MOPS.
- C. COMPLY WITH MANUFACTURERS INSTALLATION AND START-UP REQUIREMENTS

DC CIRCUIT BREAKER LABELING:

- A. NEW DC CIRCUITS REQUIRED IN MMBS CABINET SHALL BE CLEARLY IDENTIFIED AS TO RRUBEING SERVICED.
- B. LABEL CIRCUIT BREAKERS ACCORDING TO SPRINT CELL SITE ENGINEERING NOTICE EN 2012-001, REV 1.

SECTION 26 100 - BASIC ELECTRICAL REQUIREMENTS

SUMMARY:

THIS SECTION SPECIFIES BASIC ELECTRICAL REQUIREMENTS FOR SYSTEMS AND COMPONENTS.

QUALITY ASSURANCE:

- A. ALL EQUIPMENT FURNISHED UNDER DIVISION 26 SHALL CARRY UL LABELS AND LISTINGS WHERE SUCH LABELS AND LISTINGS ARE AVAILABLE IN THE INDUSTRY.
- B. MANUFACTURERS OF EQUIPMENT SHALL HAVE A MINIMUM OF THREE YEARS EXPERIENCE WITH THEIR EQUIPMENT INSTALLED AND OPERATING IN THE FIELD IN A USE SIMILAR TO THE PROPOSED USE FOR THIS PROJECT.
- C. MATERIALS AND EQUIPMENT: ALL MATERIALS AND EQUIPMENT SPECIFIED IN DIVISION 26
 OF THE SAME TYPE SHALL BE OF THE SAME MANUFACTURER AND SHALL BE NEW, OF THE
 BEST QUALITY AND DESIGN, AND FREE FROM DEFECTS.

SUPPORTING DEVICES

- A. MANUFACTURED STRUCTURAL SUPPORT MATERIALS: SUBJECT TO COMPLIANCE WITH REQUIREMENTS, PROVIDE PRODUCTS BY THE FOLLOWING:
- 1. ALLIED TUBE AND CONDUIT
- B-LINE SYSTEM
- 3. SUNISTRUT DIVERSIFIED PRODUCTS
- 4. THOMAS & BETTS

- B. FASTENERS: TYPES, MATERIALS, AND CONSTRUCTION FEATURES AS FOLLOWS:
 - 1. EXPANSION ANCHORS: CARBON STEEL WEDGE OR SLEEVE TYPE.
 - POWER-DRIVEN THREADED STUDS: HEAT-TREATED STEEL, DESIGNED SPECIFICALLY FOR THE INTENDED SERVICE.
 - 3. FASTEN BY MEANS OF WOOD SCREWS ON WOOD.
 - 4. TOGGLE BOLTS ON HOLLOW MASONRY UNITS.
 - 5. CONCRETE INSERTS OR EXPANSION BOLTS ON CONCRETE OR SOLID MASONRY
 - 6. MACHINE SCREWS, WELDED THREADED STUDS, OR SPRING-TENSION CLAMPS ON STEEL
 - EXPLOSIVE DEVICES FOR ATTACHING HANGERS TO STRUCTURE SHALL NOT BE PERMITTED.
 - 8. DO NOT WELD CONDUIT, PIPE STRAPS, OR ITEMS OTHER THAN THREADED STUDS TO STEEL STRUCTURES.
 - 9. IN PARTITIONS OF LIGHT STEEL CONSTRUCTION, USE SHEET METAL SCREWS.

HUBS AND BOXES

- A. AT ENTRANCES TO CABINETS OR OTHER EQUIPMENT NOT HAVING INTEGRAL THREADED HUBS PROVIDE METALLIC THREADED HUBS OF THE SIZE AND CONFIGURATION REQUIRED. HUB SHALL INCLUDE LOCKNUT AND NEOPRENE O-RING SEAL. PROVIDE IMPACT RESISTANT 105 DEGREE C PLASTIC BUSHINGS TO PROTECT CABLE INSULATION.
- B. CABLE TERMINATION FITTINGS FOR CONDUIT
 - CABLE TERMINATORS FOR RGS CONDUITS SHALL BE TYPE CRC BY O-Z/GEDNEY OR EQUAL BY ROX TEC.
 - CABLE TERMINATORS FOR LFMC SHALL BE ETCO CL2075; OR MADE FOR THE PURPOSE PRODUCTS BY ROXTEC.
- C. EXTERIOR PULL BOXES AND PULL BOXES IN INTERIOR INDUSTRIAL AREAS SHALL BE PLATED CAST ALLOY, HEAVY DUTY, WEATHERPROOF, DUST PROOF, WITH GASKET, PLATED IRON ALLOY COVER AND STAINLESS STEEL COVER SCREWS, CROUSE-HINDS WAB SERIES OR EQUAL.
- D. CONDUIT OUTLET BODIES SHALL BE PLATED CAST ALLOY WITH SIMILAR GASKETED COVERS. OUTLET BODIES SHALL BE OF THE CONFIGURATION AND SIZE SUITABLE FOR THE APPLICATION. PROVIDE CROUSE-HINDS FORM 8 OR EQUAL.
- E. MANUFACTURER FOR BOXES AND COVERS SHALL BE HOFFMAN, SQUARE "D", CROUSE-HINDS, COOPER, ADALET, APPLETON, O-Z GEDNEY, RACO, OR APPROVED EQUAL.

SUPPLEMENTAL GROUNDING SYSTEM:

- A. FURNISH AND INSTALL A SUPPLEMENTAL GROUNDING SYSTEM TO THE EXTENT INDICATED ON THE DRAWINGS. SUPPORT SYSTEM WITH NON-MAGNETIC STAINLESS STEEL CLIPS WITH RUBBER GROMMETS. GROUNDING CONNECTORS SHALL BE TINNED COPPER WIRE, SIZES AS INDICATED ON THE DRAWINGS. PROVIDE STRANDED OR SOLID BARE OR INSULATED CONDUCTORS EXCEPTED AS OTHERWISE NOTED.
- B. SUPPLEMENTAL GROUNDING SYSTEM: ALL CONNECTIONS TO BE MADE WITH CAD WELDS, EXCEPT AT EQUIPMENT USE LUGS OR OTHER AVAILABLE GROUNDING MEANS AS REQUIRED BY MANUFACTURER; AT GROUND BARS USE TWO HOLE SPADES WITH NO OX.
- C. STOLEN GROUND-BARS: IN THE EVENT OF STOLEN GROUND BARS, CONTACT SPRINT CM FOR REPLACEMENT INSTRUCTION USING THREADED ROD KITS.

ADDITIONAL NOTES:

- A. GC IS RESPONSIBLE FOR HIRING ALL 3RD PARTY SPECIAL INSPECTIONS AS REQUIRED PER JURISDICTION.
- GC IS RESPONSIBLE FOR VERIFYING ALL FIELD MEASUREMENTS PRIOR TO STARTING CONSTRUCTION.
- C. GC TO ENSURE HYBRID CABLES ARE SUPPORTED EVERY 3'-0" ON HORIZONTAL AND 4'-0" ON VERTICAL RUNS.
- D. DO NOT OPEN RRU PACKAGES IN THE RAIN.
- E. NO OPEN FLAME ON SITE
- MAINTAIN A MINIMUM 4-INCH CLEARANCE BETWEEN RESERVOIR SHELL AND ALL EQUIPMENT, CABLES, ETC.



PLANS PREPARED BY:



Md7, LLC 10590 West Ocean Air Dr. Suite 300 San Diego, CA 92130 858-964-7439

Md7 PROJECT NUMBER:

DRAW	/N BY:	CHECKED BY:
JC		AF
REV.	DATE:	ISSUED FOR:
A	07/31/2018	90% ZD FOR REVIEW
0	08/17/2018	100% ZD
		•

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SITE INFORMATION SITE NAME:

KELLOG PARK

SITE CASCADE: RV77XC011

SITE ADDRESS: 1635 KELLOGG AVENUE CORONA, CA 91718

SHEET TITLE:

SPRINT SPECIFICATIONS

SHEET NUMBER

SP-2



SITE ADDRESS

1635 KELLOGG AVENUE, CORONA, CA 91718

RECORD OWNER

CITY OF CORONA, A CALIFORNIA MUNICIPAL CORPORATION

TITLE REPORT

GUARANTEE TITLE REPORT WAS PREPARED BY STEWART TITLE GUARANTY COMPANY WITH GUARANTEE NO. G-2921-000000157 DATED JULY 17, 2018.

BASIS OF BEARING

THE CENTERLINE OF KELLOGG AVENUE BEARING N26'03'21"W WAS USED AS BASIS OF BEARING FOR THIS SURVEY.

BENCH MARK

SITE ELEVATIONS ARE ESTABLISHED FROM THE GPS DERIVED ORTHOMETRIC HEIGHTS BY APPLICATION OF NGS "GEOID 12A" MODELED SEPARATIONS TO ELLIPSOID HEIGHTS DETERMINED BY OBSERVATIONS OF THE "LEICA SMARTNET" REAL TIME NETWORK. ALL ELEVATIONS SHOWN HEREON ARE REFERENCED TO NAVD88

FLOODZONE

SITE IS LOCATED IN FLOOD ZONE "X" AS PER F.I.R.M. MAP NO. 06065C1356G EFFECTIVE DATE 08/28/2008.

LEGAL DESCRIPTION

THE LAND REFERRED TO HEREIN IS SITUATED IN THE STATE OF CALIFORNIA, COUNTY OF RIVERSIDE, CITY OF CORONA, AND DESCRIBED AS FOLLOWS:
ALL THOSE PORTIONS OF LOTS 6,7, 8 AND 9 IN BLOCK 47 OF LANDS OF SOUTH RIVERSIDE LAND AND WATER COMPANY, IN THE CITY OF CORONA, COUNTY OF RIVERSIDE, STATE OF CALIFORNIA, AS SHOWN BY MAP ON FILE IN BOOK 9 PAGE 6 MAPS, RECORDS OF SAN BERNARDINO COUNTY, CALIFORNIA, WHICH LIES NORTHWEST OF PARCELS 2200—332—B, 2200—333 AND 2200—338 AS SET FORTH ON A RECORD OF SURVEY FILED IN BOOK 59 PAGE 9, OF RECORDS OF SURVEY, RIVERSIDE COUNTY RECORDS; EXCEPTING THAT PORTION WHICH LIES NORTH OF THE SOUTH BOUNDARY LINE OF TRACT NO. 25904 AS SHOWN ON THE PLAT MAP THEREOF RECORDED IN BOOK 247 PAGES 82 THROUGH 85 OF MAPS, RIVERSIDE COUNTY REFORMS.

SCHEDULE B

ITEMS 1-4 & 14,17 ARE TAX/LIENS RELATED ITEMS 5,6,16 & 20 ARE RIGHTS RELATED ITEMS 9-13,15,18 & 19 ARE DEED RELATED


PROPERTY LINES ARE BASED FROM

7. AN EASEMENT FOR CONDUITS AND RIGHTS INCIDENTAL THERETO AS SET FORTH IN A DOCUMENT RECORDED JANUARY 26, 1888 IN BOOK 69 PAGE 109 OF DEEDS AND RECORDED JULY 18, 1887 IN BOOK 62 PAGE 329 OF DEEDS OF SAN BERNARDINO COUNTY.

SUPPORTING DOCUMENT FOR THE EASEMENT IS NOT ILLEGIBLE/NOT PLOTTABLE.

AN EASEMENT FOR PUBLIC UTILITIES AND RIGHTS INCIDENTAL THERETO IN FAVOR OF SOUTHERN CALIFORNIA EDISON COMPANY AND PACIFIC TELEPHONE COMPANY, AS SET FORTH IN A DOCUMENT RECORDED MAY 31, 1984 AS INSTRUMENT NO. 115953, OF OFFICIAL RECORDS, AFFECTS A PORTION OF SAID LAND.

DATED MARCH 24, 1994

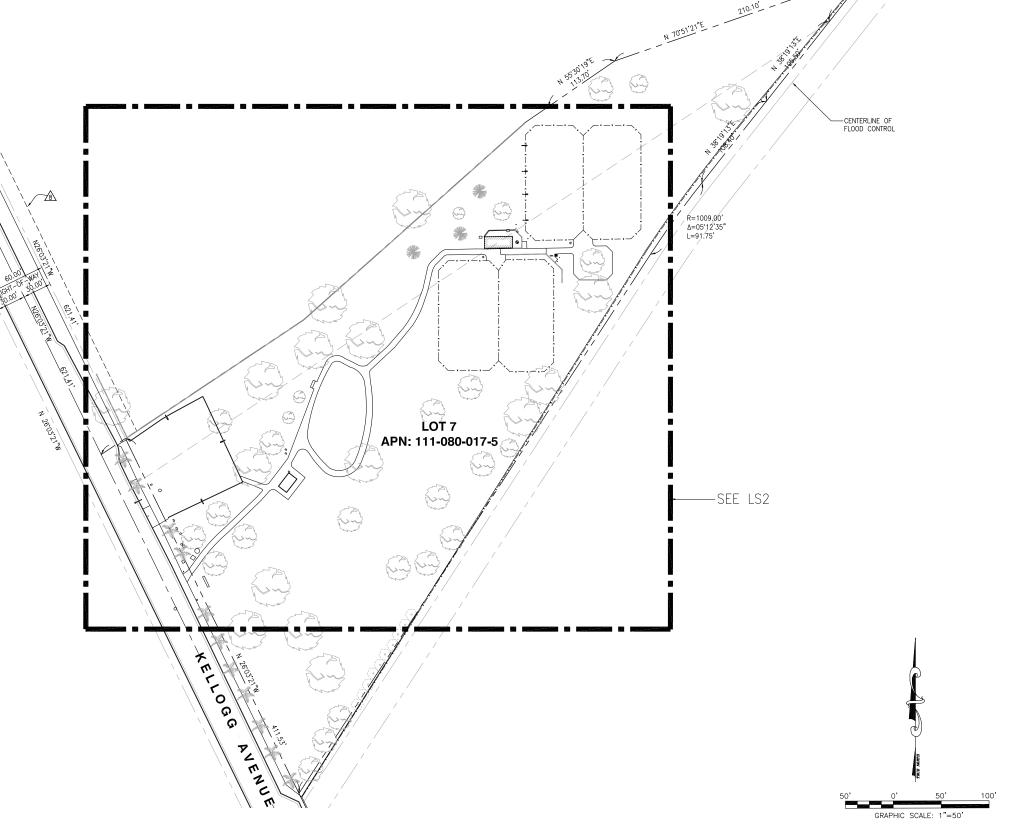



N 51'38'39"W / 9.03'





10650 SCRIPPS RANCH BLVD., SUITE 224 SAN DIEGO, CA 92131 tel: (858) 433-7173 / (858) 433-7176

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П	2	08/14/2018	FINAL SURVEY
П	1	07/30/2018	PRELIM SURVEY
	REV	DATE	DESCRIPTION

ISSUED DATE: -

AUGUST 14, 2018

ISSUED FOR: -

FINAL SURVEY

LICENSURE: L.S. 8780 Exp. 12/31/18

PROJECT -INFORMATION:

RV77XC011 KELLOG PARK 1635 KELLOGG AVENUE CORONA, CA 91718


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١	CHECKED BY:	MP

SHEET-TITLE: -

TOPOGRAPHIC SURVEY

SHEET-NUMBER: •

LS-1

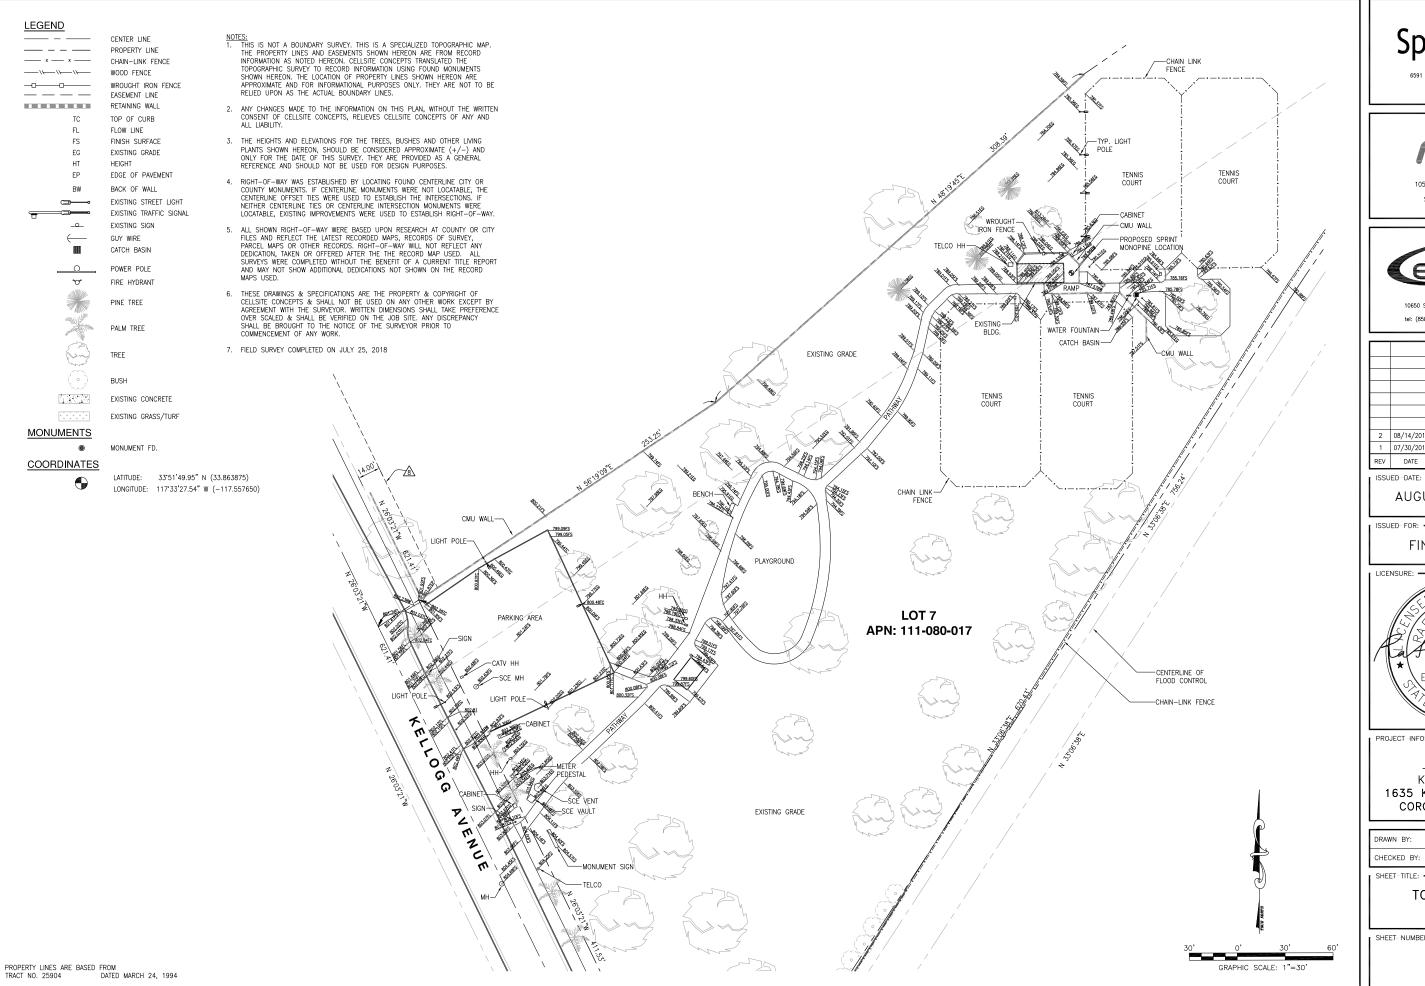



10590 WEST OCEAN AIR DR. SAN DIEGO, CA 92130



2 08/14/2018 FINAL SURVEY 1 | 07/30/2018 | PRELIM SURVEY

ISSUED DATE:

AUGUST 14, 2018

DESCRIPTION

ISSUED FOR: -

FINAL SURVEY

LICENSURE:



PROJECT INFORMATION:

RV77XC011 KELLOG PARK 1635 KELLOGG AVENUE CORONA, CA 91718


DRAWN BY: APL

SHEET-TITLE:

TOPOGRAPHIC SURVEY

SHEET-NUMBER:

LS-2

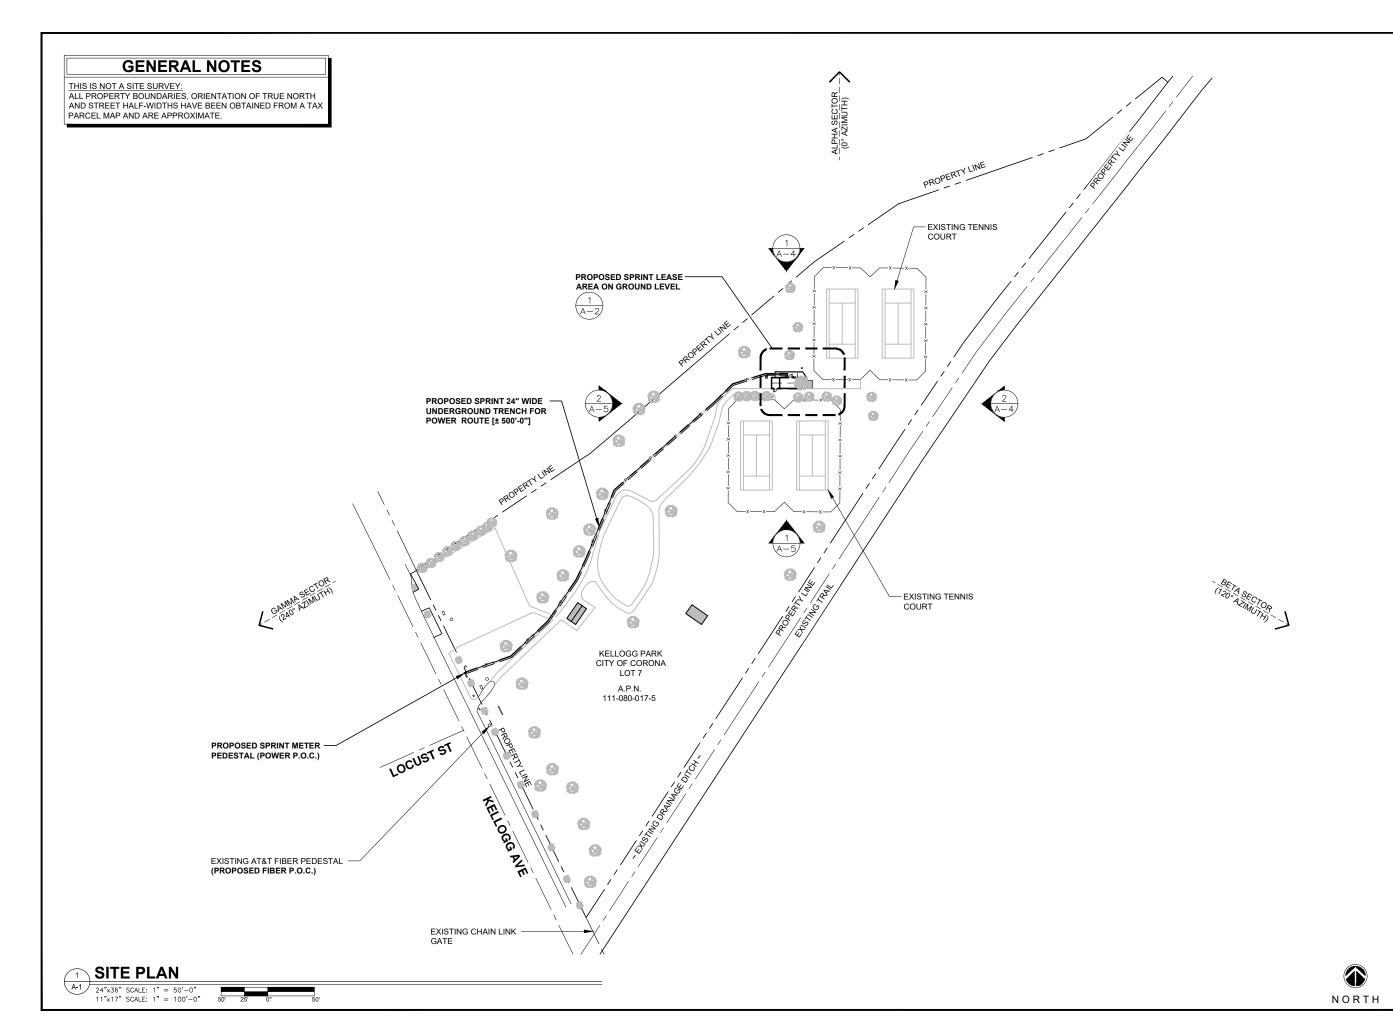



PLANS PREPARED BY:



Md7, LLC 10590 West Ocean Air Dr. Suite 300 San Diego, CA 92130 858·964·7439

Md7 PROJECT NUMBER:

DRAW	/N BY:	CHECKED BY:
JC		AF
REV.	DATE:	ISSUED FOR:
A	07/31/2018	90% ZD FOR REVIEW
- 0	08/17/2018	100% ZD
-		
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All drawings and written material contained herein may not be duplicated, used or disclosed without the written consent of the architect.

SITE INFORMATION: SITE NAME:

KELLOG PARK


SITE CASCADE: RV77XC011

SITE ADDRESS:

1635 KELLOGG AVENUE CORONA, CA 91718

SHEET TITLE:

OVERALL SITE PLAN

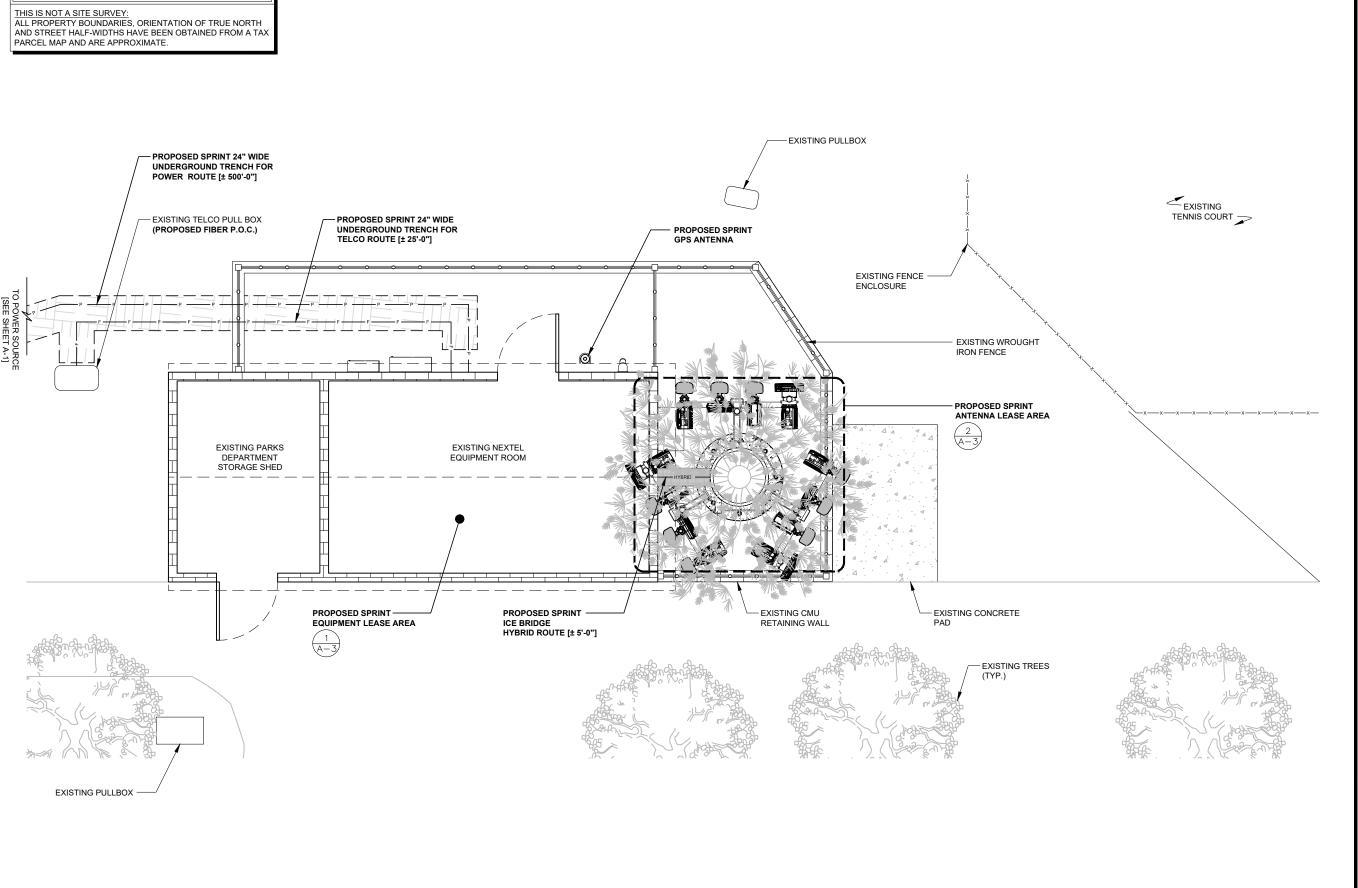

GENERAL NOTES

ENLARGED SITE PLAN A-2 24"x36" SCALE: 3/8" = 1'-0" 2' 1' 0" 2'



PLANS PREPARED BY:



10590 West Ocean Air Dr. Suite 300 San Diego, CA 92130 858-964-7439

Md7 PROJECT NUMBER:

DRAV	VN BY:	CHECKED BY:
JC		AF
REV.	DATE:	ISSUED FOR:
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		•

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SITE INFORMATION: SITE NAME:

KELLOG PARK

SITE CASCADE: RV77XC011 SITE ADDRESS:

1635 KELLOGG AVENUE


CORONA, CA 91718

SHEET TITLE:

ENLARGED SITE PLAN

SHEET NUMBER:

NORTH

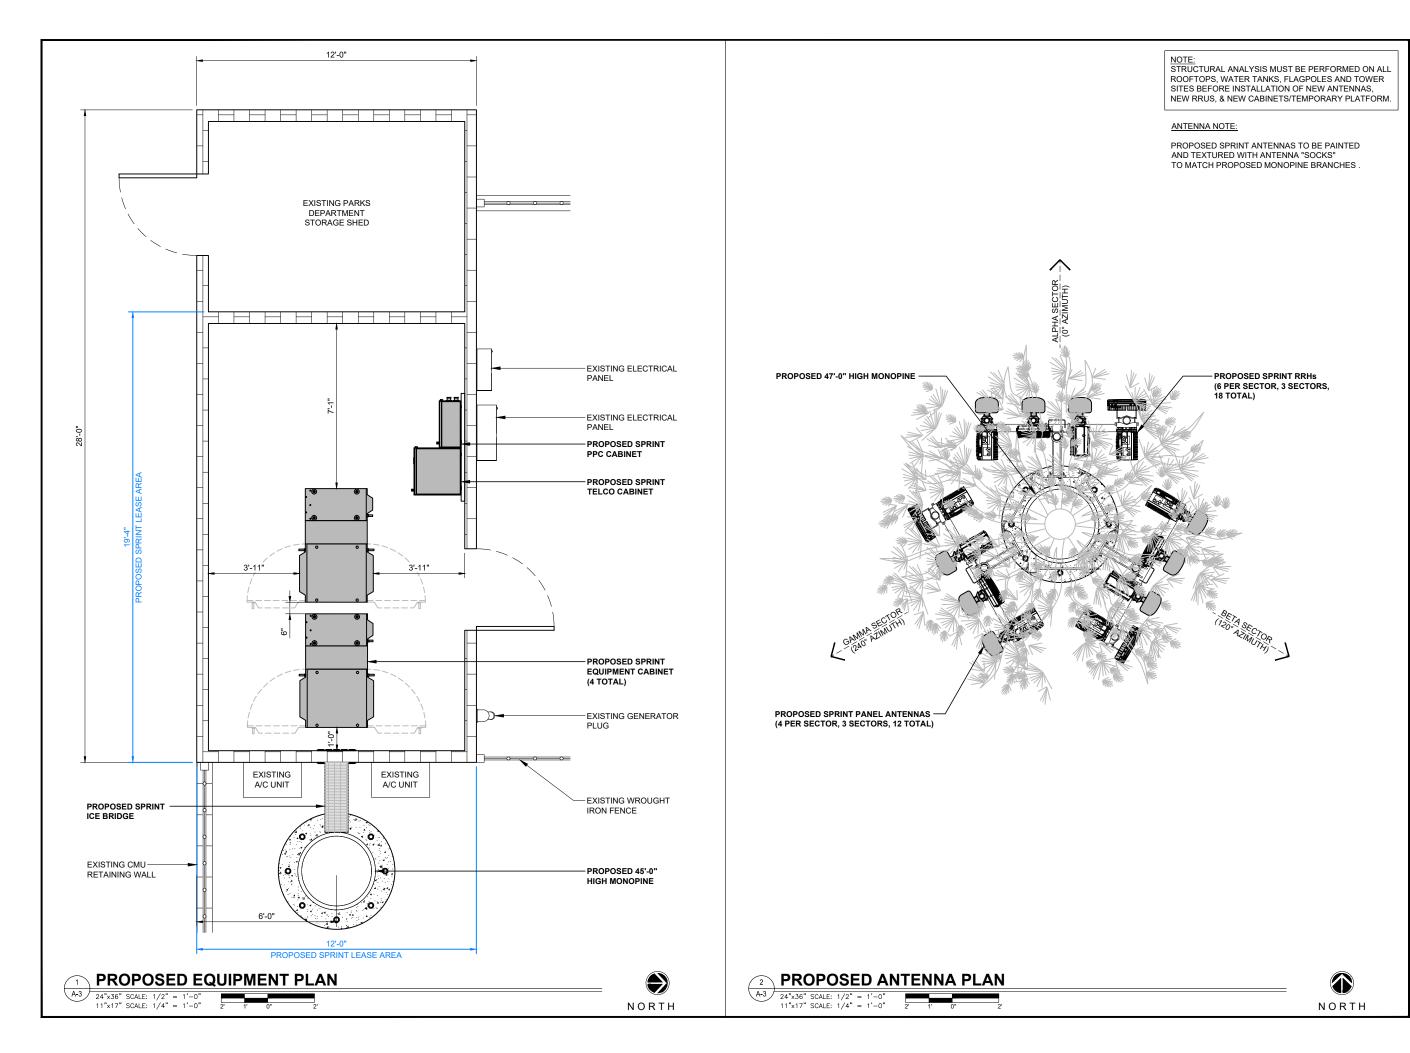

Sprint 🎾

12657 ALCOSTA BLVD SUITE 300 SAN RAMON, CA 94583

PLANS PREPARED BY:



Md7, LLC 10590 West Ocean Air Dr. Suite 300 San Diego, CA 92130 858-964-7439

Md7 PROJECT NUMBER:

DRAV	/N BY:	CHECKED BY:	
JC		AF	
REV.	DATE:	ISSUED FOR:	
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SITE INFORMATION: SITE NAME:

KELLOG PARK

SITE CASCADE: RV77XC011

SITE ADDRESS: 1635 KELLOGG AVENUE


CORONA, CA 91718

SHEET TITLE:

EQUIPMENT AND ANTENNA PLANS

SHEET NUMBER:

A-3

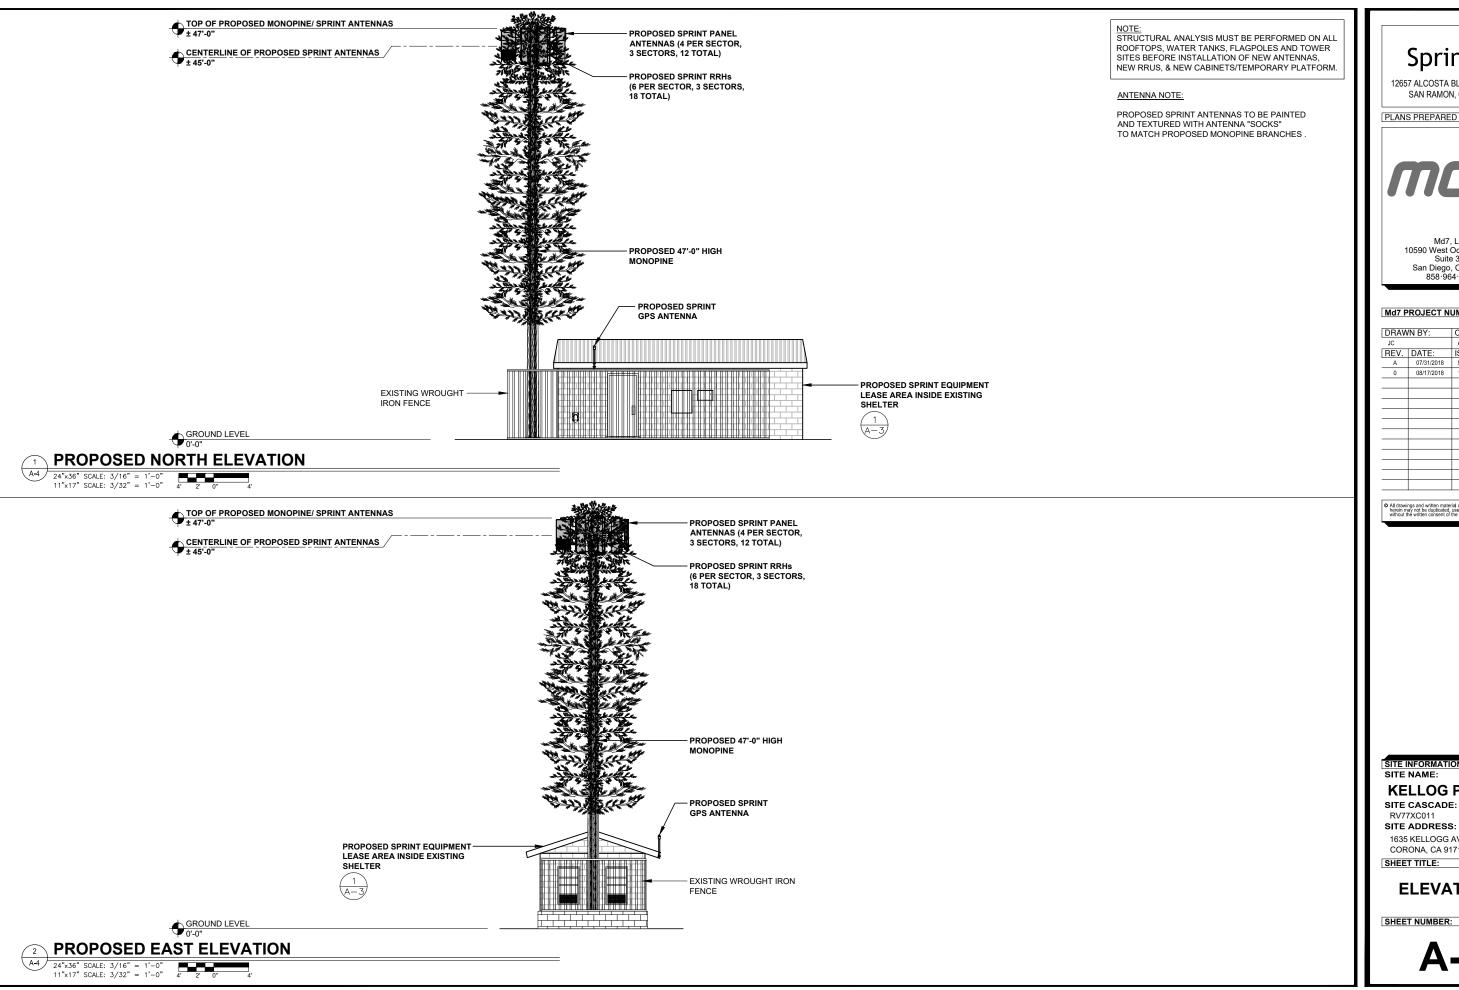



12657 ALCOSTA BLVD SUITE 300 SAN RAMON, CA 94583

PLANS PREPARED BY:



10590 West Ocean Air Dr. Suite 300 San Diego, CA 92130 858·964·7439

Md7 PROJECT NUMBER:

DRAW	/N BY:	CHECKED BY:
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REV.	DATE:	ISSUED FOR:
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- 0	08/17/2018	100% ZD
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SITE INFORMATION: SITE NAME:

KELLOG PARK


SITE CASCADE: RV77XC011

1635 KELLOGG AVENUE

CORONA, CA 91718

SHEET TITLE:

ELEVATIONS

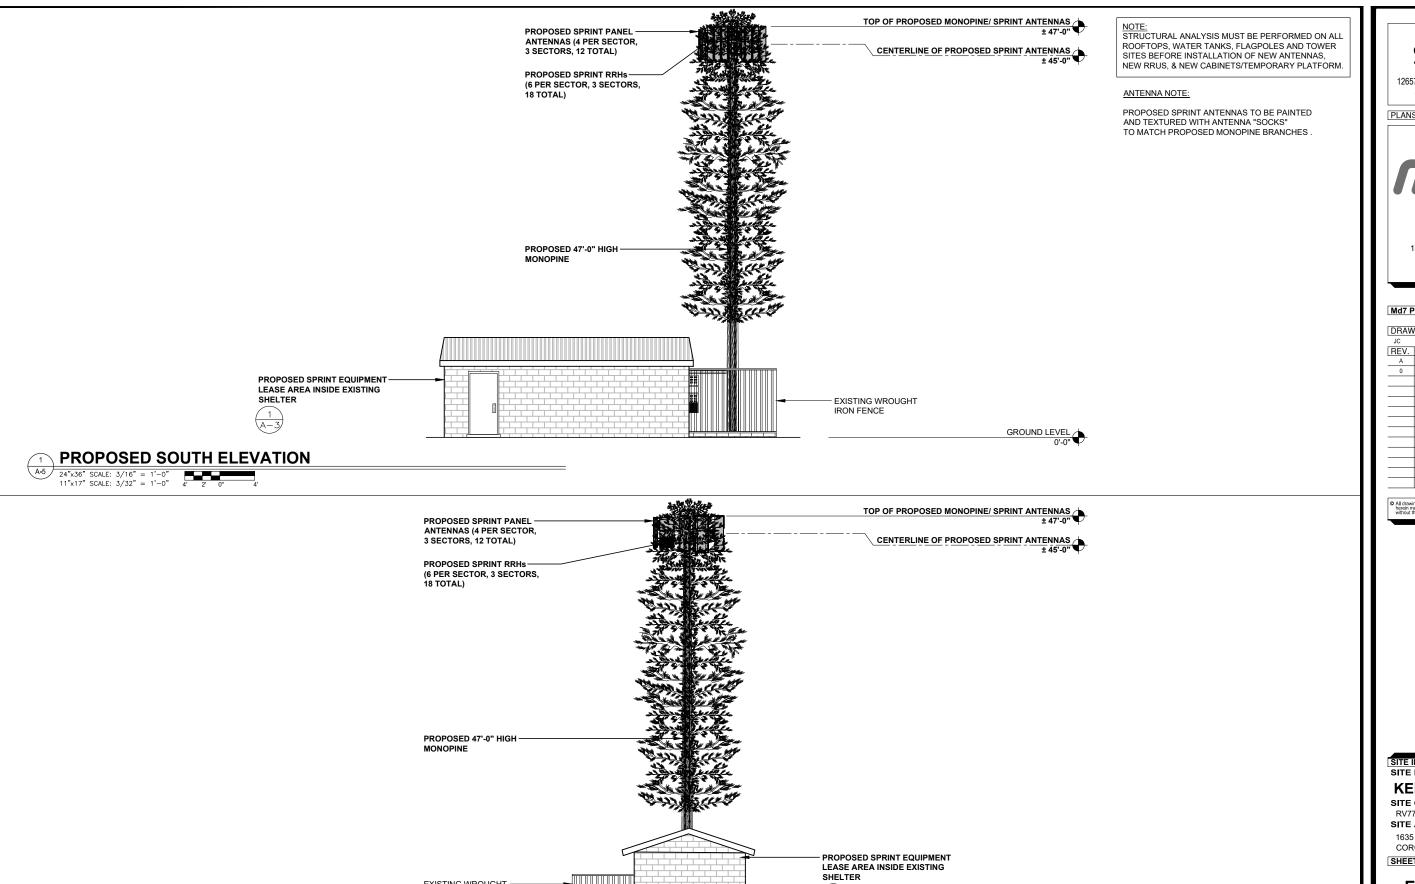

 $\begin{pmatrix} 1 \\ A-3 \end{pmatrix}$

GROUND LEVEL 0'-0"

EXISTING WROUGHT

IRON FENCE

PROPOSED WEST ELEVATION

24"x36" SCALE: 3/16" = 1'-0" 11"x17" SCALE: 3/32" = 1'-0" 4' 2' 0" 4'

12657 ALCOSTA BLVD SUITE 300 SAN RAMON, CA 94583

PLANS PREPARED BY:



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SITE INFORMATION: SITE NAME:

KELLOG PARK

SITE CASCADE: RV77XC011 SITE ADDRESS:

1635 KELLOGG AVENUE CORONA, CA 91718

SHEET TITLE:

ELEVATIONS